


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PROPOSED NEW RESIDENCE AT: 901 NORTH OCEAN BOULEVARD

> ARCOM PRESENTATION B-034-2018 MARCH 28, 2018, APRIL 25, 2018, MAY 23, 2018, SEPTEMBER 26, 2018



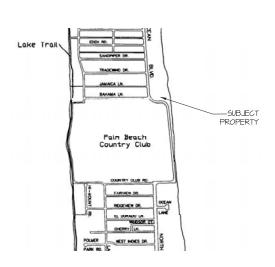

LOCATION MAP
PALM BEACH, FL
N.T.S.

TOWN OF PALM BEACH

NING TABULATION	N
REGUIRED/ALLOWED	PROPOSED
141	RA
20,000 SF MIN.	50,02058 S.F.
125' MIN.	173'-4"
150' MIN.	399'-11"
2 DJJ./ACRE	
35'-O"	35'-3"
15'-0"	15'-2"
15'-0"	48'-10"
25'-0"/ 2 STORIES	22'-8"
35'-0"	32'- <i>0</i> "
25%	18.5%
(12,505.14 S.F. MAX.)	4,263 S.F.
50% MIN.	60%
25,010 S.F.	30,333 S.F.
45% MIN.	58%
II,254.63 S.F.	14,528 S.F.
	REQUIRED/ALLOWED RA 20,000 SF MIN. 125' MIN. 180' MIN.

SQUARE FOOT DATA	Proposed
LOT AREA FOR CALCULATIONS:	50,020 S.F.
ALLOWABLE LOT COVERAGE:	(25%) 12,505 S.F.
PROPOSED LOT COVERAGE:	(185%) 4,263 S.F.
AIR CONDITIONED SPACE:	
IST FLOOR:	5,580 S.F.
2ND FLOOR:	3,432 S.F.
MAIN HOUSE A/C TOTAL	9,012 S.F.
GUEST HOUSE A/C TOTAL:	1,253 S.F.
COVERED NON A/C SPACE	
MAIN - BALCONIES, COV. TERRACE, PAVILION	1,897 S.F.
GUEST - COVERED PORCH	5I S.F.
GARAGES: EAST	576 S.F.
WEST	788 S.F.
BASEMENT:	3,6TT S.F.
TOTAL ABOVE GRADE SQ.FT.	13,5TT 5Q.FT

NUMBER OF S	STORIES: TWO
	IAL: WHITE FLAT TILE YES NO
COLORS:	
BUILDING:	BENJAMIN MOORE WHITE - SUPER WHITE - OC-152
RAILINGS:	WHITE
ROOF:	WHITE FLAT TILE
TRIM:	WHITE - PAINTED STUCCO
SHUTTERS:	PAINTED LOUVER - BM - HC-123 KENNEBUNKPORT GREEN
WINDOWS:	PAINTED IMPACT SINGLE HUNG GREEN TEA LEAF WHITE BRICKMOLD
DOORS:	PAINTED WOOD IMPACT-WHITE

ARCOM B-034-2017

STYLE AND DESCRIPTION:

STYLE: ISLAND COLONIAL DESCRIPTION:

PALM BEACH COUNTY, FLORIDA

NEIGHBORING PROPERTY DATA

FOOTPRINT=8,819 SF | FOOTPRINT=7,969 SF

TOTAL = 3,270 SF

<u>947 N Ocean Blvd</u>

TOTAL = 25,390 SF

LOT COVERAGE=22.1% | LOT COVERAGE=11.1% | LOT COVERAGE=15.2%

TOTAL = 3,368 SF

LOT SIZE=10,018 SF

2-STORY RESIDENCE

TOTAL = 4,566 SF

FOOTPRINT=2,828 SF

LOT COVERAGE=28.2%

<u>1029 N Ocean Blva</u>

2-STORY RESIDENCE

TOTAL = 16,334 SF

DATA TABLE * PROPOSED RESIDENCE – ALL PROPERTY INFORMATION TAKEN FROM PALM BEACH COUNTY PROPERTY APPRAISER, ZILLOW, TRULIA AND CORCORAN GROUP.

_OT SIZE=±19,349 SF | LOT SIZE=±19,880 SF | LOT SIZE=±12,196 SF | LOT SIZE=±11,325 SF | LOT SIZE=±11,325 SF | LOT SIZE=±11,325 SF

FOOTPRINT=6,375 SF | FOOTPRINT=5,234 SF | FOOTPRINT=3,120 SF | FOOTPRINT=2,930 SF | FOOTPRINT=3,270 SF | FOOTPRINT=1,834 SF LOT COVERAGE=32.9% | LOT COVERAGE=26.3% | LOT COVERAGE=25.5% | LOT COVERAGE=25.8% | LOT COVERAGE=28.8% | LOT COVERAGE=16.1%

LOT SIZE=±10,454 SF LOT SIZE=3,659,475 SF LOTSIZE=±50,020.58SF LOT SIZE=±96,267 SF LOT SIZE=±79,279 SF LOT SIZE=±52,272 SI

FOOTPRINT=9,580 SF | FOOTPRINT=21,337 SF |

TOTAL =3,944 SF

2-STORY RESIDENCE | 2-STORY RESIDENCE | 2-STORY RESIDENCE

TOTAL = 23,956 SF

201 Bahama Lane 207 Bahama Lane

1-STORY RESIDENCE 2-STORY RESIDENCE

1-STORY RESIDENCE | 2-STORY RESIDENCE | 2-STORY RESIDENCE | 2-STORY RESIDENCE | 1-STORY RESIDENCE

LOT SIZE=±11,325 SF LOT SIZE=±11,216 SF LOT SIZE=±13,939 SF LOT SIZE=±10,454 SF LOT SIZE=13,068 SF

TOTAL = 5,224 SF

FOOTPRINT=2,040 SF | FOOTPRINT=3,476 SF | FOOTPRINT=5,224 SF | FOOTPRINT=3,229 SF | FOOTPRINT=3,353 SF

LOT COVERAGE=18.0% LOT COVERAGE=31.0% LOT COVERAGE=37.4% LOT COVERAGE=30.8% LOT COVERAGE=25.6%

TOTAL = 20,359 SF

LOT COVERAGE=19%

217 Bahama Lane 760 N Ocean Blvd *901 N Ocean Blvd 911 N Ocean Blvd

2-STORY RESIDENCE | 2-STORY RESIDENCE | 1-STORY RESIDENCE |

GOLF COURSE

TOTAL = NA

FOOTPRINT=NA

TOTAL = 3,720 SF | TOTAL = 5,756 SF


LOT COVERAGE=29.0% LOT COVERAGE=NA%

<u>260 Jamaica Lane|291 Jamaica Lane</u> LOT SIZE= \pm 11,264 SF LOT SIZE= \pm 11,264 S 1-STORY RESIDENCE | 1-STORY RESIDENCE TOTAL = 2,921 SF | TOTAL = 4,516 SF FOOTPRINT=2,921 SF | FOOTPRINT=4,516 SF LOT COVERAGE=25.9% LOT COVERAGE=40.0%

1-STORY RESIDENCE

TOTAL = 3,033 SF

FOOTPRINT=3,033 SF

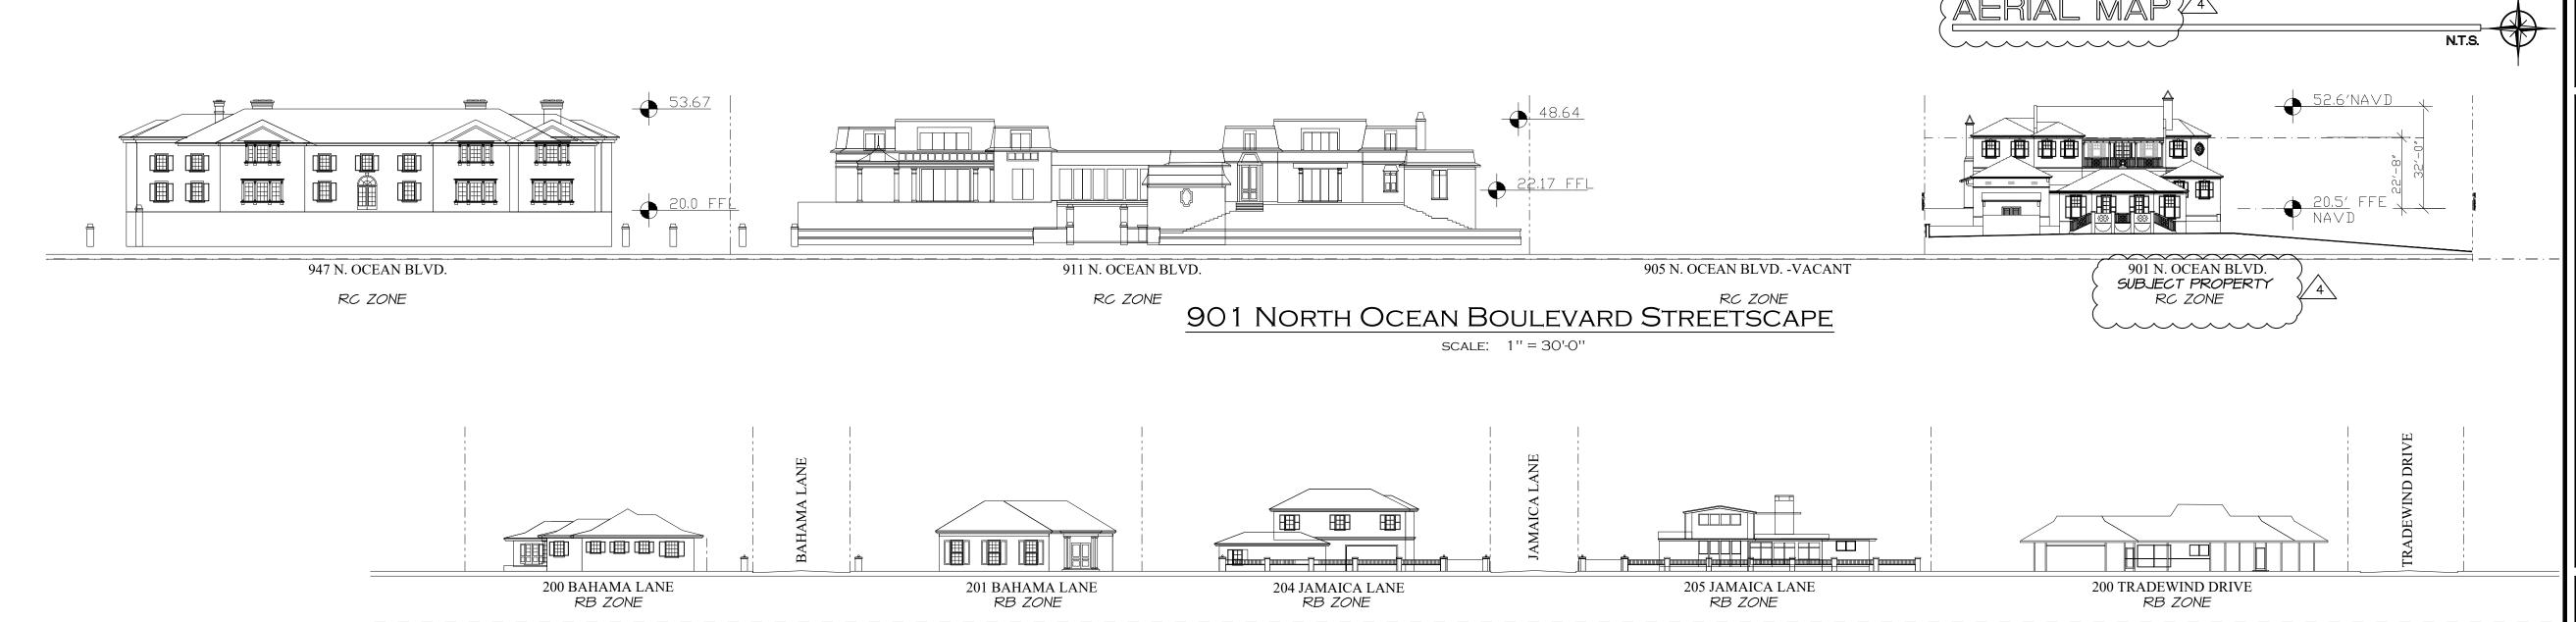

NEIGHBORING STREETSCAPE ELEVATIONS

SCALE: 1" = 30'-0"

ARCHITE

SEN

Job No. 17-119



Drawing No.

SP-1.02









200 Tradwind Drive



216 Tradewind Drive



204 Jamaica Lane



205 Jamaica Lane



210 Jamaica Lane



214 Jamaica Lane

NEIGHBORHOOD COMPARISON







215 Jamaica Lane



221 Jamaica Lane



200 Bahama Lane



201 Bahama Lane



207 Bahama Lane

NEIGHBORHOOD COMPARISON



208 Bahama Lane







217 Bahama Lane



947 N Ocean Blvd



911 N Ocean Blvd



Vacant Lot N Ocean Blvd



*901 N Ocean Blvd



760 N Ocean Blvd

NEIGHBORHOOD COMPARISON











NORTH OCEAN BOULEVARD










SOUTHEAST
SUBJECT PROPERTY
901 NORTH OCEAN BOULEVARD



NORTHEAST - ADJACENT LOT

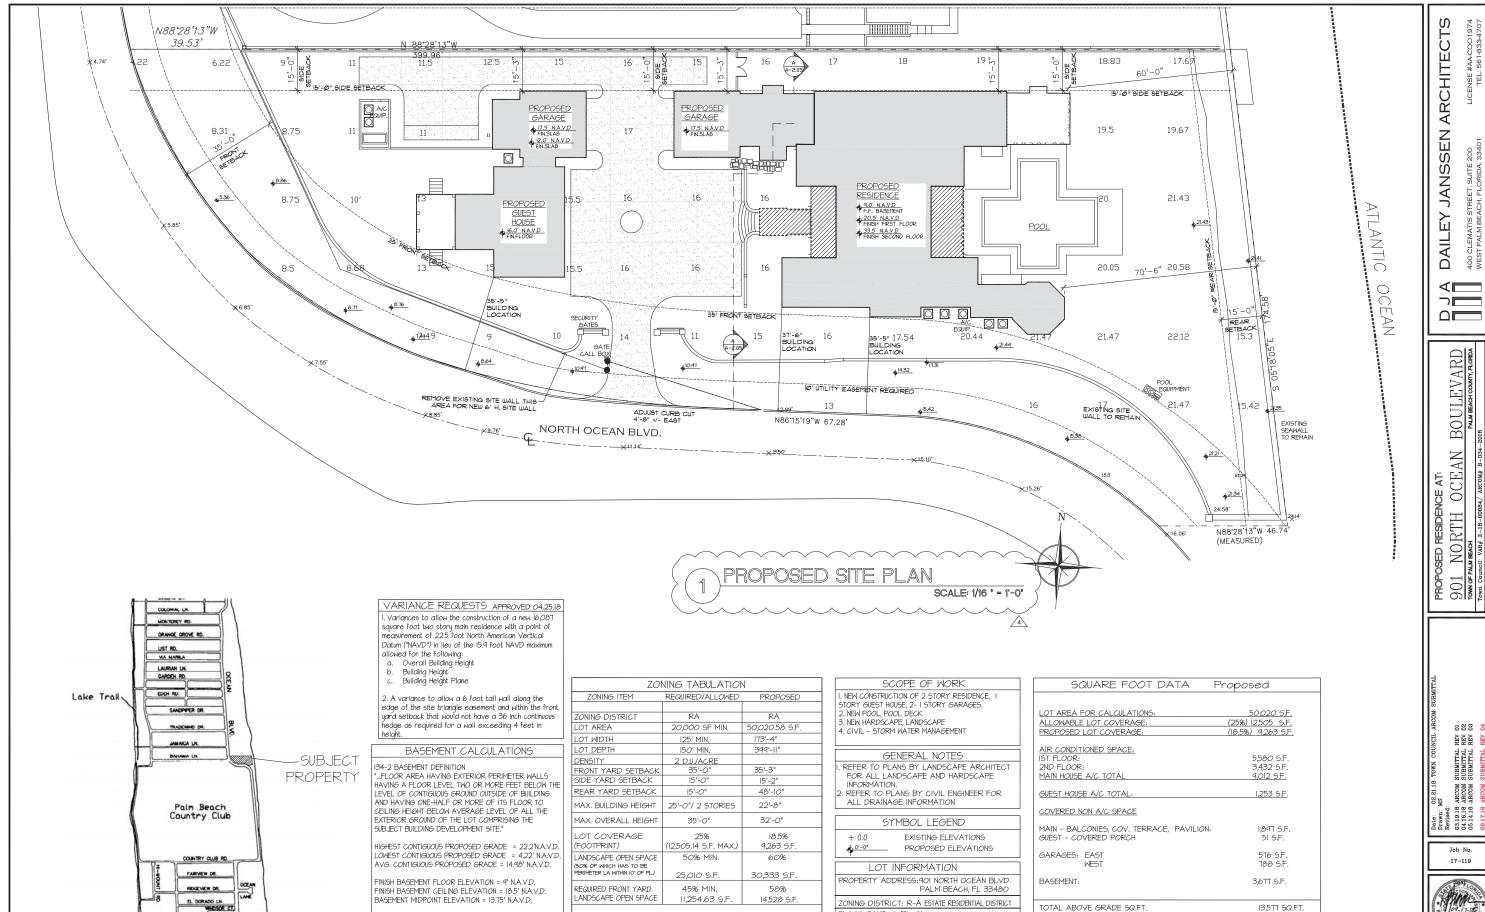

WEST INDIES DR

N.T.S.

LOCATION MAP

FLOOD ZONE: C (EL. 9)

DATE OF SURVEY: 06.12.17

ALL SURVEY INFORMATION BASED ON SURVEY BY: MERIDIAN LAND SURVEYORS

PH. 772-794-1213, EMAIL:LB6905@BELLSOUTH.NET


1717 INDIAN RIVER BLVD, SUITE 201 VERO BEACH, FL 32960 LB#6905


RESIDENCE AT () RTH () C.F. PROPOSED RESIDEN
901 NORTH
TOWN OF PALM BEACH
Town Council: VAR# Z-18-0008 020 22 REV REV REV

ARCOM SARCOM SARCOM S

SP-1.0


N.T.S.

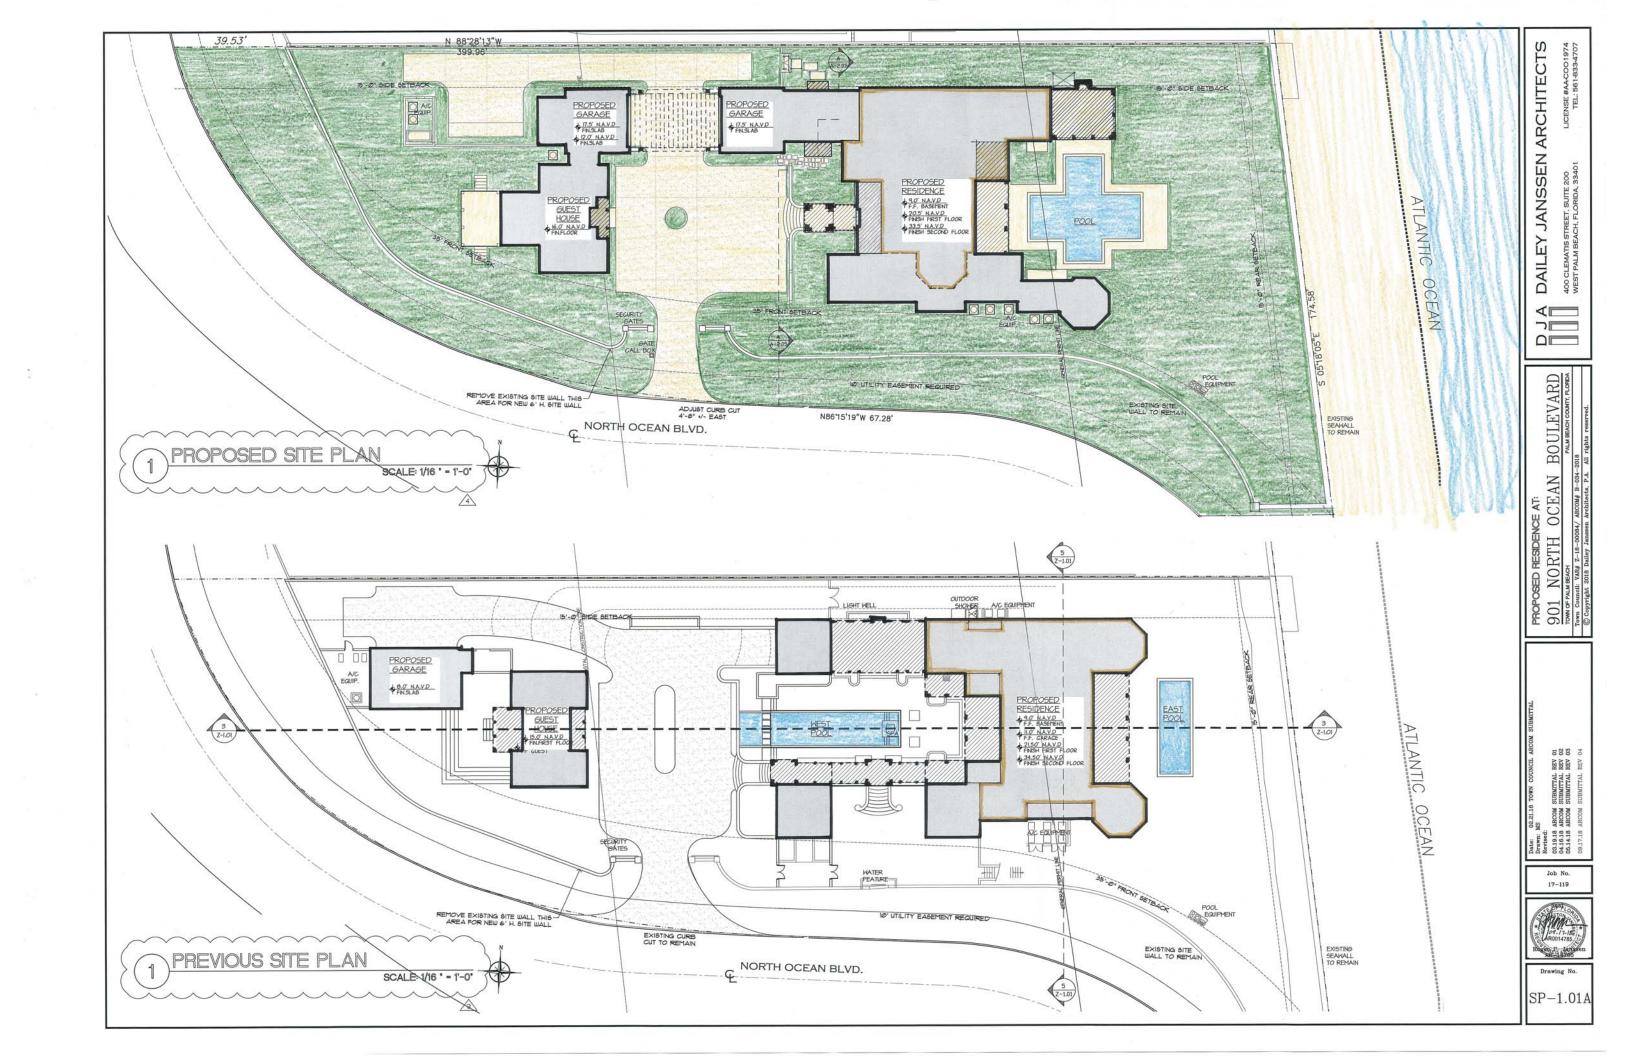


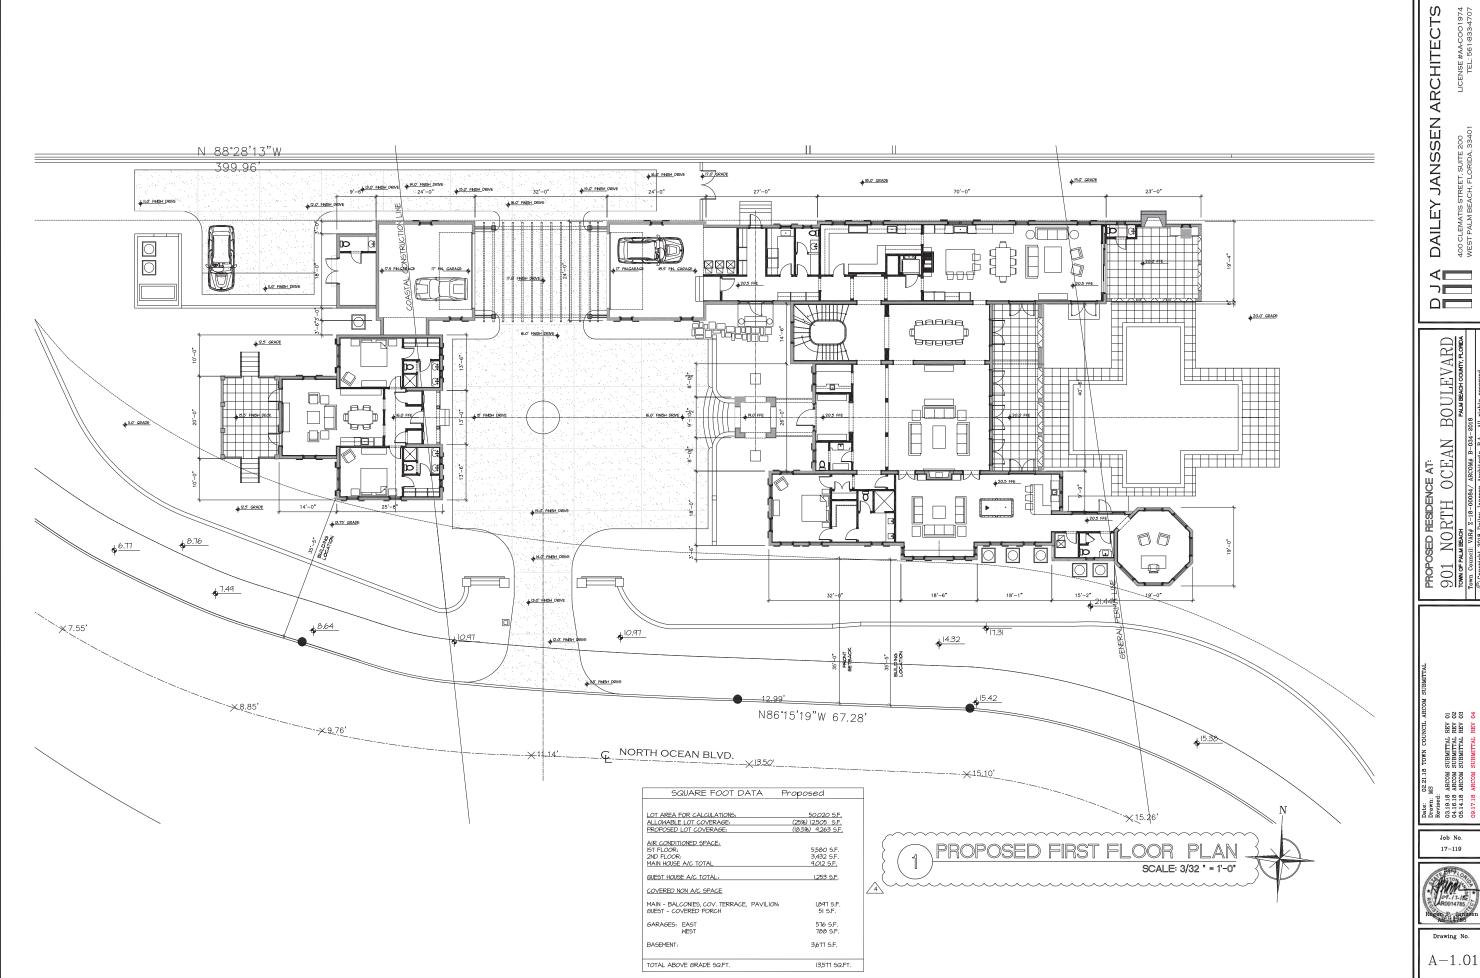


LICENSE #AA-COO1974 TEL: 561-833-4707

Drawing No. A - 1.01

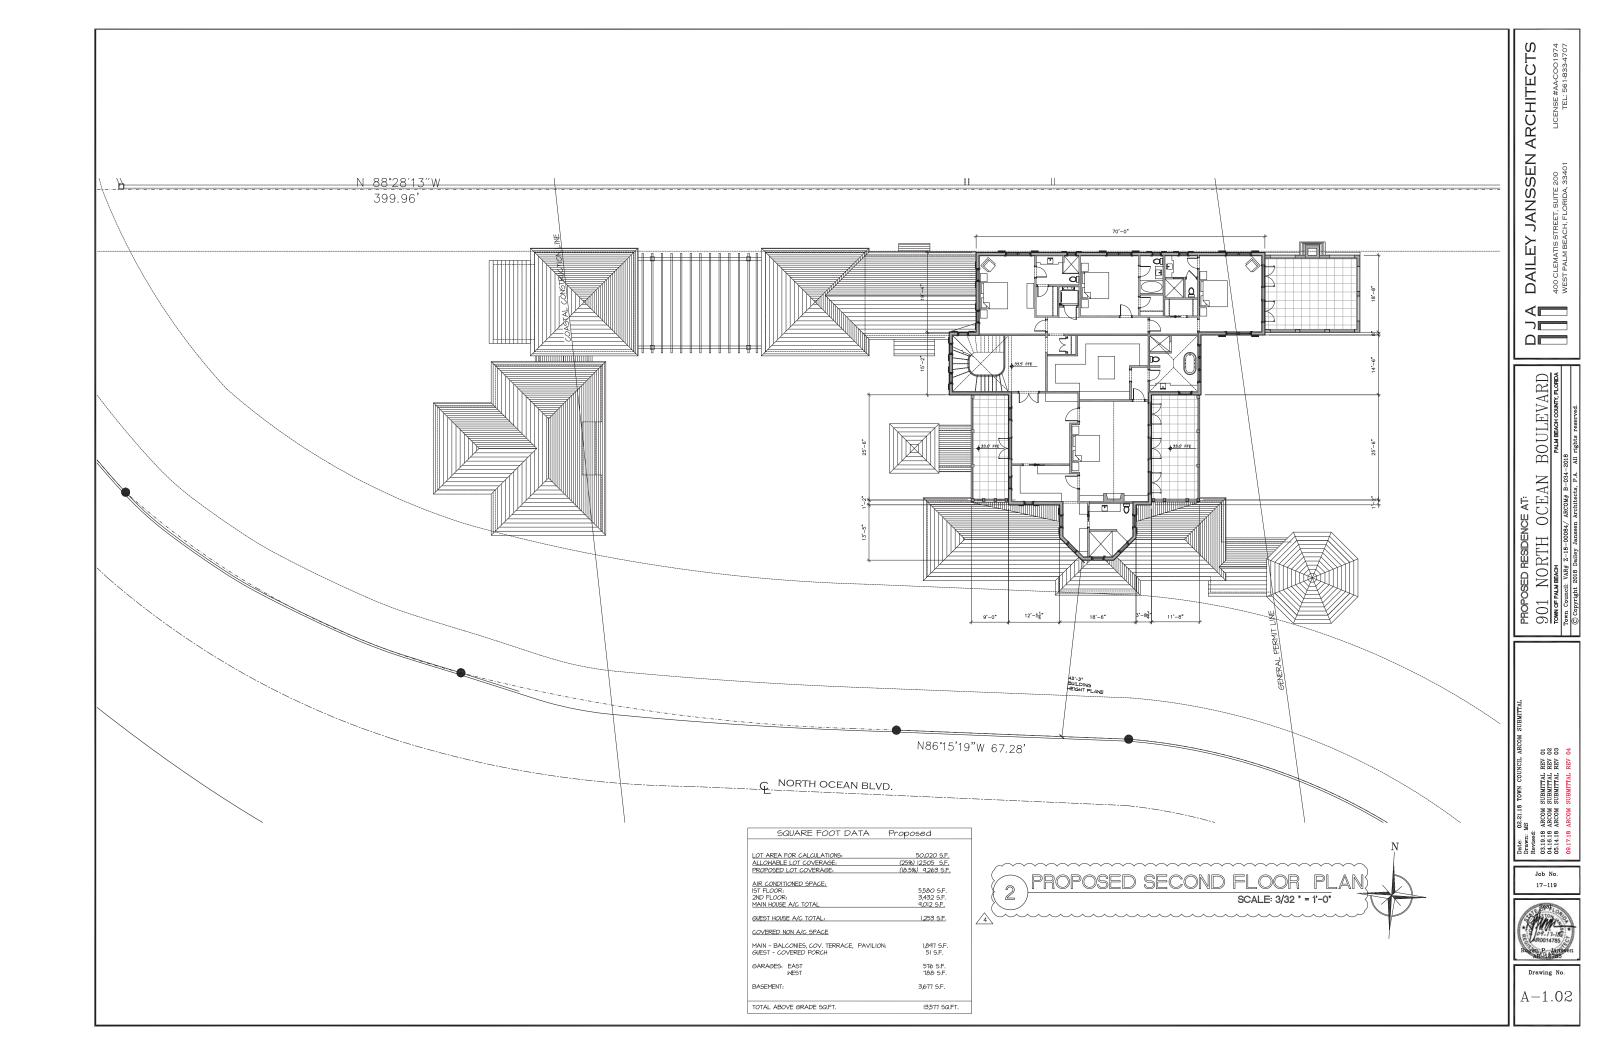

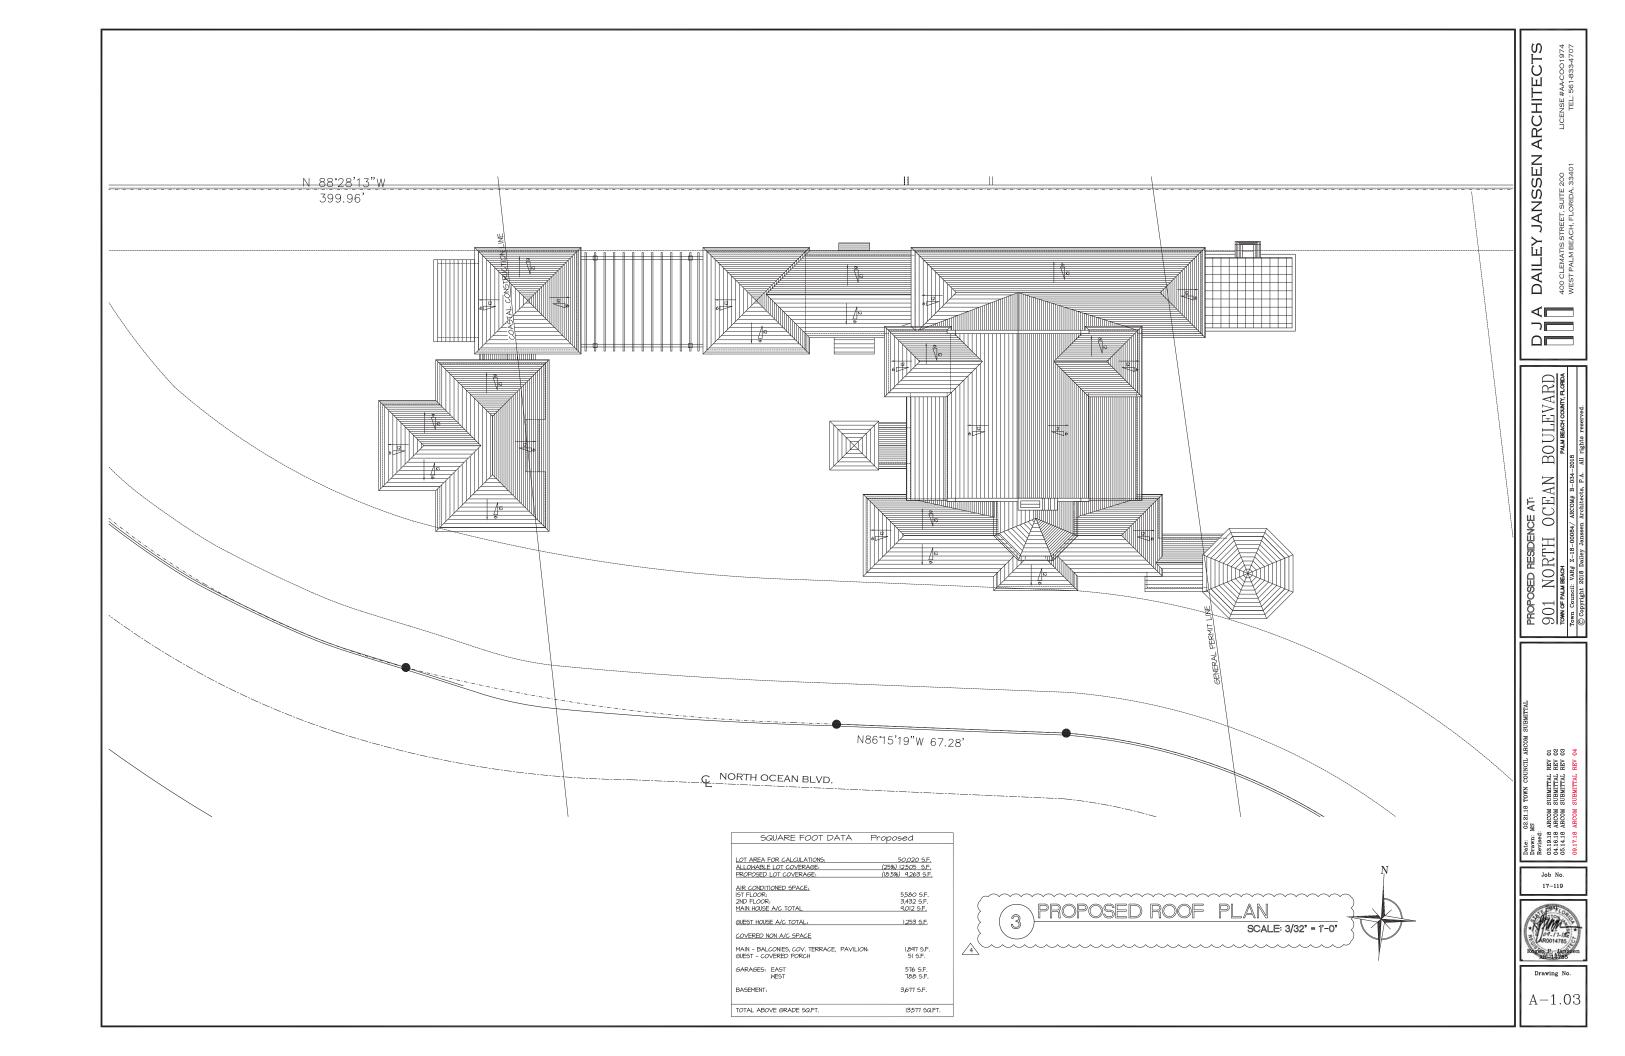

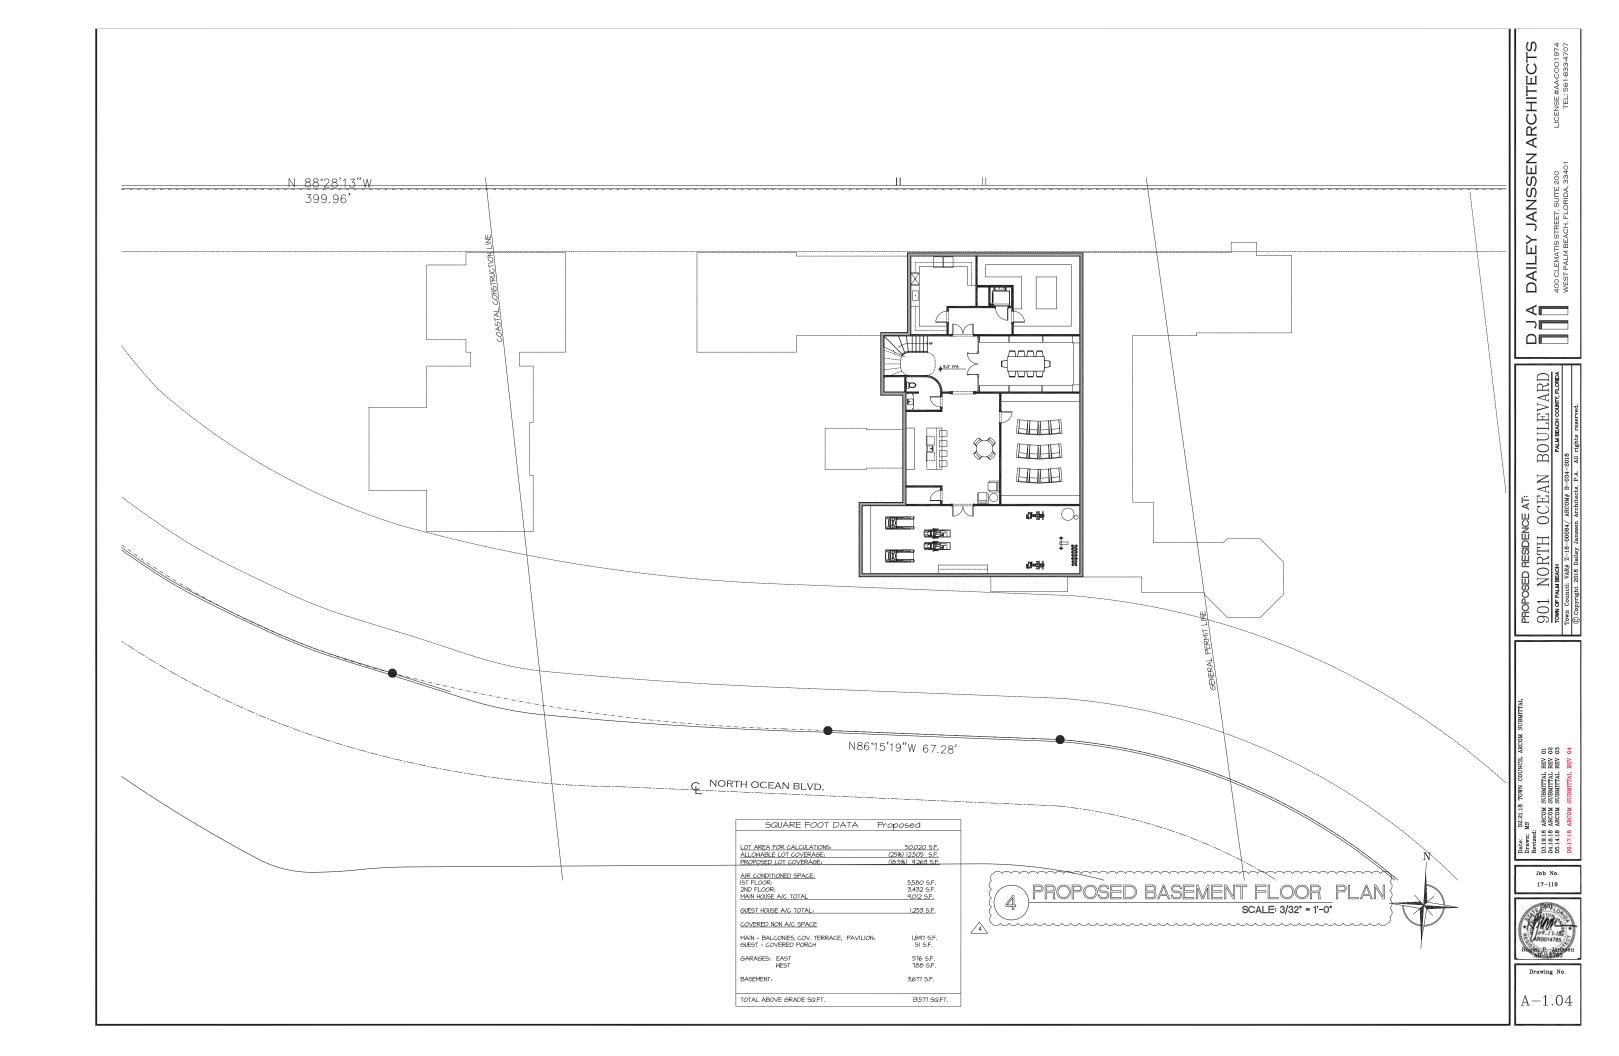



SCALE 3/16"= 1'-0"

PROPOSED RESIDENCE AT:
901 NORTH OCEAN BOULEVARD
TOWN OF PALM BEACH
TOWN OF DALM BEACH
TOWN COMMITTEN STATE OWE BE - 034-2018
© comprometal: 2018 Dalley Janssen Architects, P.A. All Tablis reserved.

DAILEY JANSSEN ARCHITECTS

LICENSE #AA-COO1974 TEL: 561-833-4707

400 CLEMATIS STREET, SUITE 200 WEST PALM BEACH, FLORIDA, 33401

D J A

Date: 022118 TOWN COUNCIL ARCON Drawn. MS Review. BS Review B ARCOM SUBMITAL REV 02 64.16 ARCOM SUBMITAL REV 02 66.14.18 ARCOM SUBMITAL REV 03





PROPOSED SOUTH ELEVATION - MAIN HOUSE

SCALE 3/16"= 1'-0"

DAILEY JANSSEN ARCHITECTS

LICENSE #AA-COO1974 TEL: 561-833-4707

400 CLEMATIS STREET, SUITE 200 WEST PALM BEACH, FLORIDA, 33401

4 | | |

Date: 00.21.18 TOWN COUNCIL ARCOM Drawn: MS Revised: 05.19.18 ARCOM SUBMITAL REV 02 05.14.18 ARCOM SUBMITAL REV 02 05.14.18 ARCOM SUBMITAL REV 03 09.17.18 ARCOM SUBMITAL REV 03





PROPOSED EAST ELEVATION - MAIN HOUSE

SCALE 3/16*= 1'-0*

PROPOSED RESIDENCE AT:
901 NORTH OCEAN BOULEVARD
TOWN OF PALM BEACH
TOWN COMMIT, NAR 2-18-00084, ARCONG B-054-2018


DAILEY JANSSEN ARCHITECTS


LICENSE #AACOO1974 TEL: 561-833-4707

D 7 P

Date: 02.21.16 TOWN COUNCIL ARCON Drewn: MS Rovised: 03.19.18 ARCOM SUBMITAL REW 02.14.18 ARCOM SUBMITAL REW 03 05.14.18 ARCOM SUBMITAL REW 03 09.17.18 ARCOM SUBMITAL REW 04



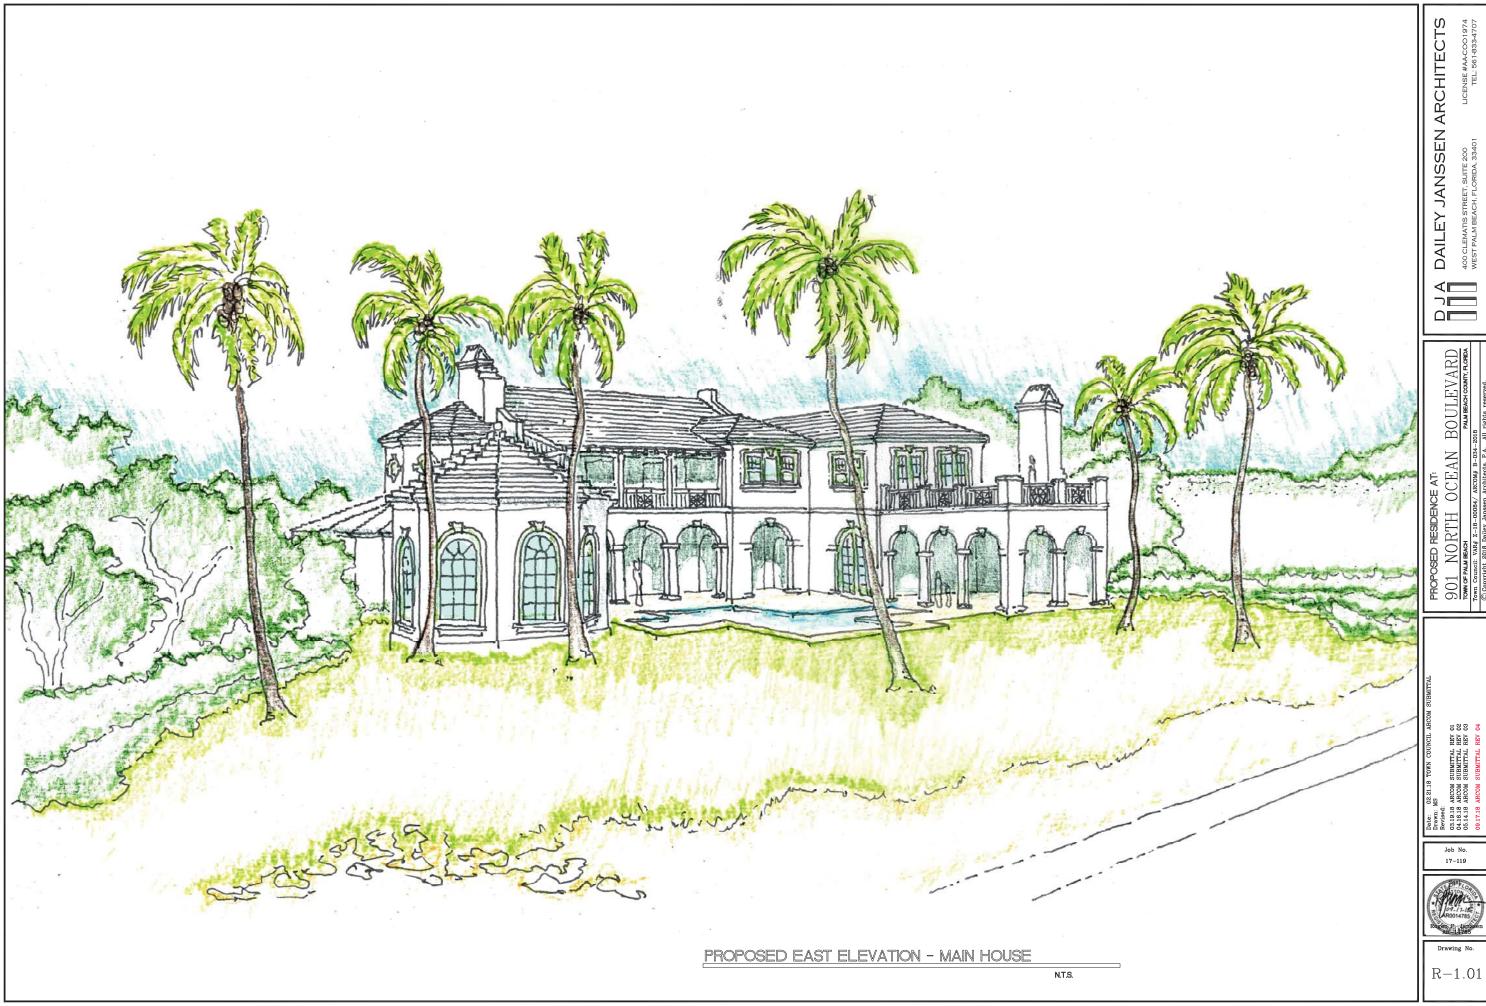

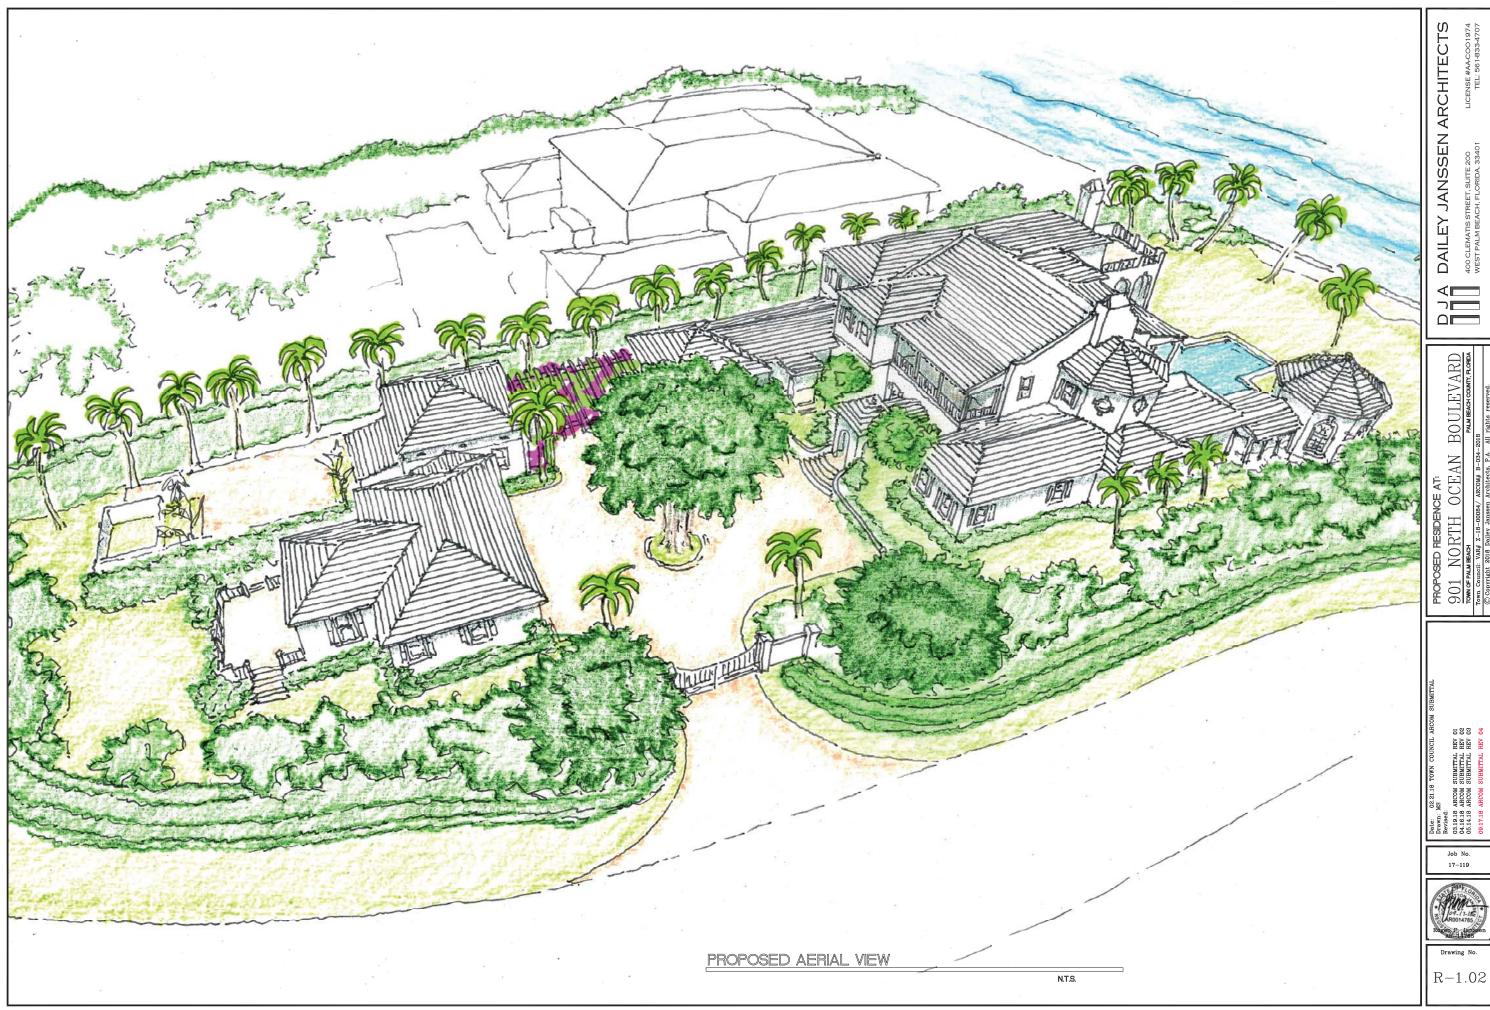

DAILEY JANSSEN ARCHITECTS

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PROPOSED RESIDENCE AT:
901 NORTH OCEAN BOULEVARD
TOWN OF PAUM BEACH
TOWN COUNCIL: VARY Z-19-00084/ ARCOM# B-034-2018

Drawing No

9 03 03 REV REV REV

ARCOM SUBMITTAL FARCOM SUBMITTAL FARCOM SUBMITTAL FARCOM STIPMINITAL F

Date: 0
Drawn: M.
Revised: 03.19.18 / 04.16.18 / 05.14.18 /

Job No.

17-119

A - 2.01



Drawing No. A-2.02







PREVIOUS SOUTH ELEVATION SCALE 3/32"= 1'-0"

COLORS:

BUILDING: BEN IAMIN MOORE

ROOF: WHITE FLAT TILE, COPPER

TRIM: WHITE - PAINTED STUCCO

PAINTED LOUVER - HC 123 - KENNEBUNKPORT GREEN SHUTTERS:

GREEN TEA LEAF - IMPACT SINGLE HUNG W/ WHITE BRICKMOLD

WHITE-IMPACT WOOD

SUPER WHITE - OC-152

• FLAT TILE ROOF - WHITE

COPPER HALF ROUND GUTTERS
 SMOOTH SPONGE FINISH STUCCO WALLS PAINTED WHITE

• STRUCTURAL OUTLOOKERS - PAINTED WHITE

• STUCCO TRIM, SILL - PAINTED WHITE

PAINTED WOOD IMPACT RATED SINGLE HUNG WINDOWS- WHITE
 PAINTED WOOD IMPACT RATED

FRENCH DOORS- WHITE

• PAINTED WOOD IMPACT RATED SLIDING

4

DOORS - WHITE

PAINTED RAILS - WHITE

OPERABLE LOUVER SHUTTERS -HC 123 - KENNEBUNKPORT GREEN

PROPOSED RESIDENCE AT:
901 NORTH OCEAN |
rown of pauliticists
Town Council: VARy 2-18-00084/ ARCOMy B-034-20

9 03 03 REV REV REV ARCOM SUBMITTAL FARCOM SUBMITTAL FARCOM SUBMITTAL FARCOM STIPMINITAL F

Date: 0
Drawn: M.
Revised: 03.19.18 / 04.16.18 / 05.14. Job No.

17-119


Drawing No A - 2.03

+ 22'-8" T.O.TIE BEAM + 13'-0" FINISH 2ND FLOOR + 9'-8" T.O.TIE BEAM O'-O"/2O'-<u>6" N.A.V.D</u> FINISH FLOOR MEASURING POINT

> PROPOSED EAST ELEVATION - MAIN HOUSE SCALE 3/32"= 1'-0"



PREVIOUS EAST ELEVATION - MAIN HOUSE SCALE 3/32"= 1'-0"

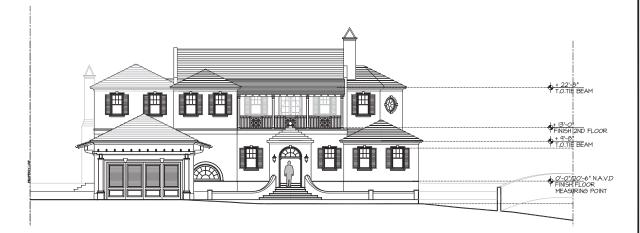

SCALE 3/32"= 1'-0"



PREVIOUS WEST ELEVATION - MAIN HOUSE SCALE 3/32"= 1'-0"

COLORS:

BUILDING: BEN IAMIN MOORE SUPER WHITE - OC-152

ROOF:

SHUTTERS:

GREEN TEA LEAF

• FLAT TILE ROOF - WHITE

COPPER HALF ROUND GUTTERS
 SMOOTH SPONGE FINISH STUCCO WALLS PAINTED WHITE

• STRUCTURAL OUTLOOKERS - PAINTED WHITE

• STUCCO TRIM, SILL - PAINTED WHITE

PAINTED WOOD IMPACT RATED SINGLE HUNG WINDOWS- WHITE
 PAINTED WOOD IMPACT RATED

FRENCH DOORS- WHITE

• PAINTED WOOD IMPACT RATED SLIDING

DOORS - WHITE

PAINTED RAILS - WHITE

OPERABLE LOWER SHUTTERS -HC 123

- KENNEBUNKPORT GREEN) 👍



WHITE FLAT TILE, COPPER TRIM: WHITE - PAINTED STUCCO PAINTED LOUVER - HC 123 - KENNEBUNKPORT GREEN

- IMPACT SINGLE HUNG W/ WHITE BRICKMOLD

WHITE - IMPACT WOOD

ARCOM SUBMITTAL REV 01
ARCOM SUBMITTAL REV 02
ARCOM SUBMITTAL REV 03
ARCOM SUBMITTAL REV 04 Date: 0
Drawn: M.
Revised: 03.19.18 / 04.16.18 / 05.14.18 /

Job No. 17-119



A - 2.04

+ I4'-2" T.O.TIE BEAM _____ + 9'-6" • T.O.TIE BEAM •

> PROPOSED EAST ELEVATION - GUEST HOUSE SCALE 3/32"= 1'-0"



PREVIOUS EAST ELEVATION - GUEST HOUSE SCALE 3/32"= 1'-0"



PROPOSED WEST ELEVATION -GUEST HOUSE

SCALE 3/32"= 1'-0"



4

PREVIOUS WEST ELEVATION - GUEST HOUSE

SCALE 3/32"= 1'-0"

COLORS:

BUILDING: BEN IAMIN MOORE SUPER WHITE - OC-152

ROOF: WHITE FLAT TILE, COPPER TRIM:

WHITE - PAINTED STUCCO PAINTED LOUVER - HC 123 - KENNEBUNKPORT GREEN SHUTTERS:

WINDOWS

GREEN TEA LEAF - IMPACT WOOD SINGLE HUNG

WHITE-IMPACT WOOD DOORS:

• FLAT TILE ROOF - WHITE

COPPER HALF ROUND GUTTERS
 SMOOTH SPONGE FINISH STUCCO WALLS PAINTED WHITE

• STRUCTURAL OUTLOOKERS - PAINTED WHITE


STRICTURAL OUTLOOKERS - PAINTED WHITE
STIVCCO TRIM, SILL - PAINTED WHITE
PAINTED WOOD IMPACT RATED
SINGLE HUNG WINDOWS- WHITE
PAINTED WOOD IMPACT RATED
FRENCH DOORS- WHITE
PAINTED WOOD IMPACT RATED SLIDING

DOORS - WHITE

PAINTED RAILS - WHITE

OPERABLE LOWER SHUTTERS -HC 123

- KENNEBUNKPORT GREEN) 👍

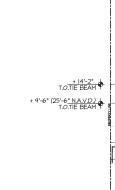



LICENSE #AA-COO1974 TEL: 561-833-4707

DAILEY JANSSEN ARCHITECTS


PROPOSED RESIDENCE AT:
901 NORTH OCEAN BOULEVARD
TOWN OF PALM BEACH COMMY, ALCORDA
TOWN COURTENT WAR Z - 18 - 00084/ ARCON§ B-034-2018

Date: 0221.18 TOWN COUNCIL ARCOD Drawn. MS Review 10 03.19 B. ARCOM SUBMITFAL REV 02 03.19 B. ARCOM SUBMITFAL REV 02 06.14 B. ARCOM SUBMITFAL REV 03 09.17.18 ARCOM SUBMITFAL REV 03

Job No. 17-119



Drawing No. A-2.05

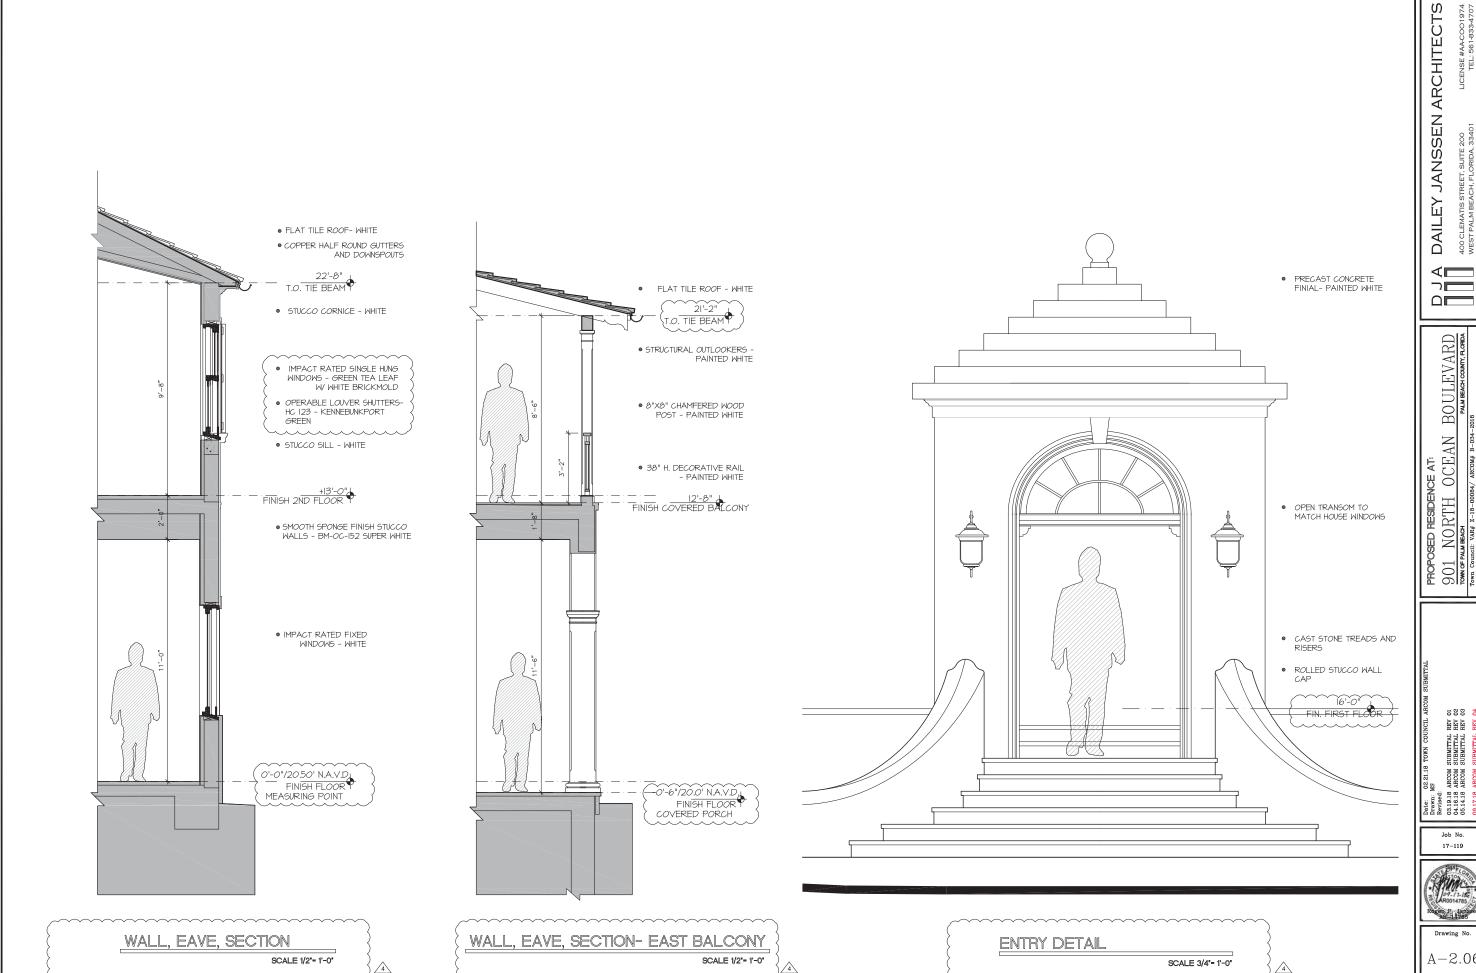


BOULEVARD PALM BEACH COUNTY, PLOSEDA

A - 2.06

REV 01 REV 02 REV 03 REV 04

ARCOM SUBMITTAL F
ARCOM SUBMITTAL F
ARCOM SUBMITTAL F

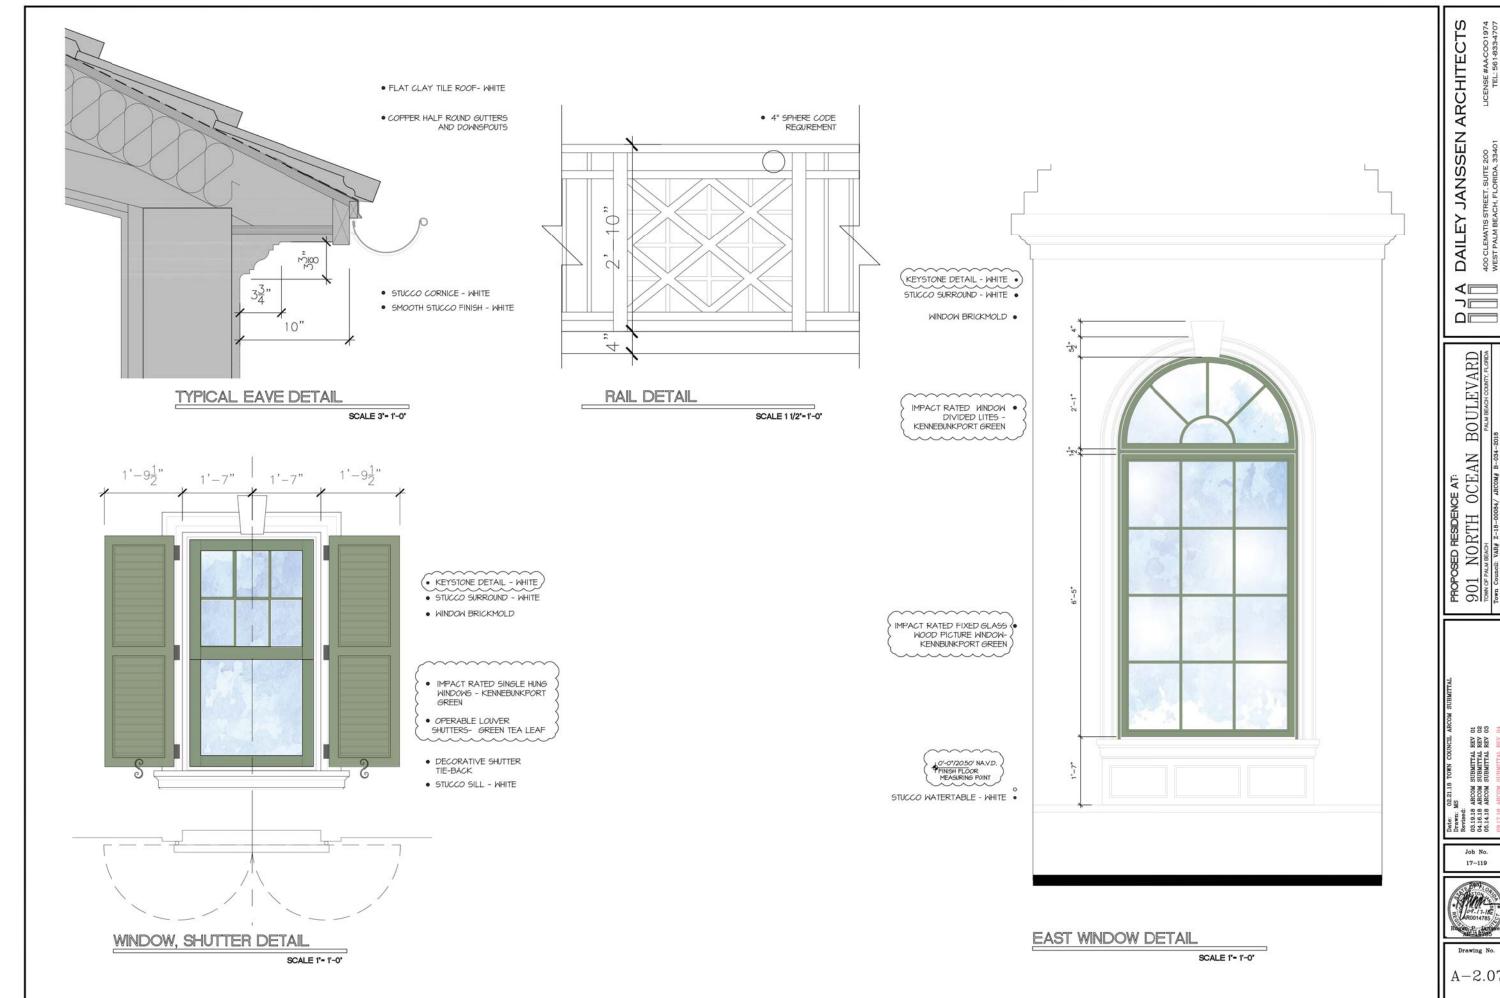

BOULEVARD PALM BEACH COUNTY, FLORIDA

LICENSE #AA-COO1974 TEL: 561-833-4707

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02 03

REV REV REV

ARCOM SUBMITTAL B ARCOM SUBMITTAL B ARCOM SUBMITTAL B














ARCHITECTURAL INSPIRATION

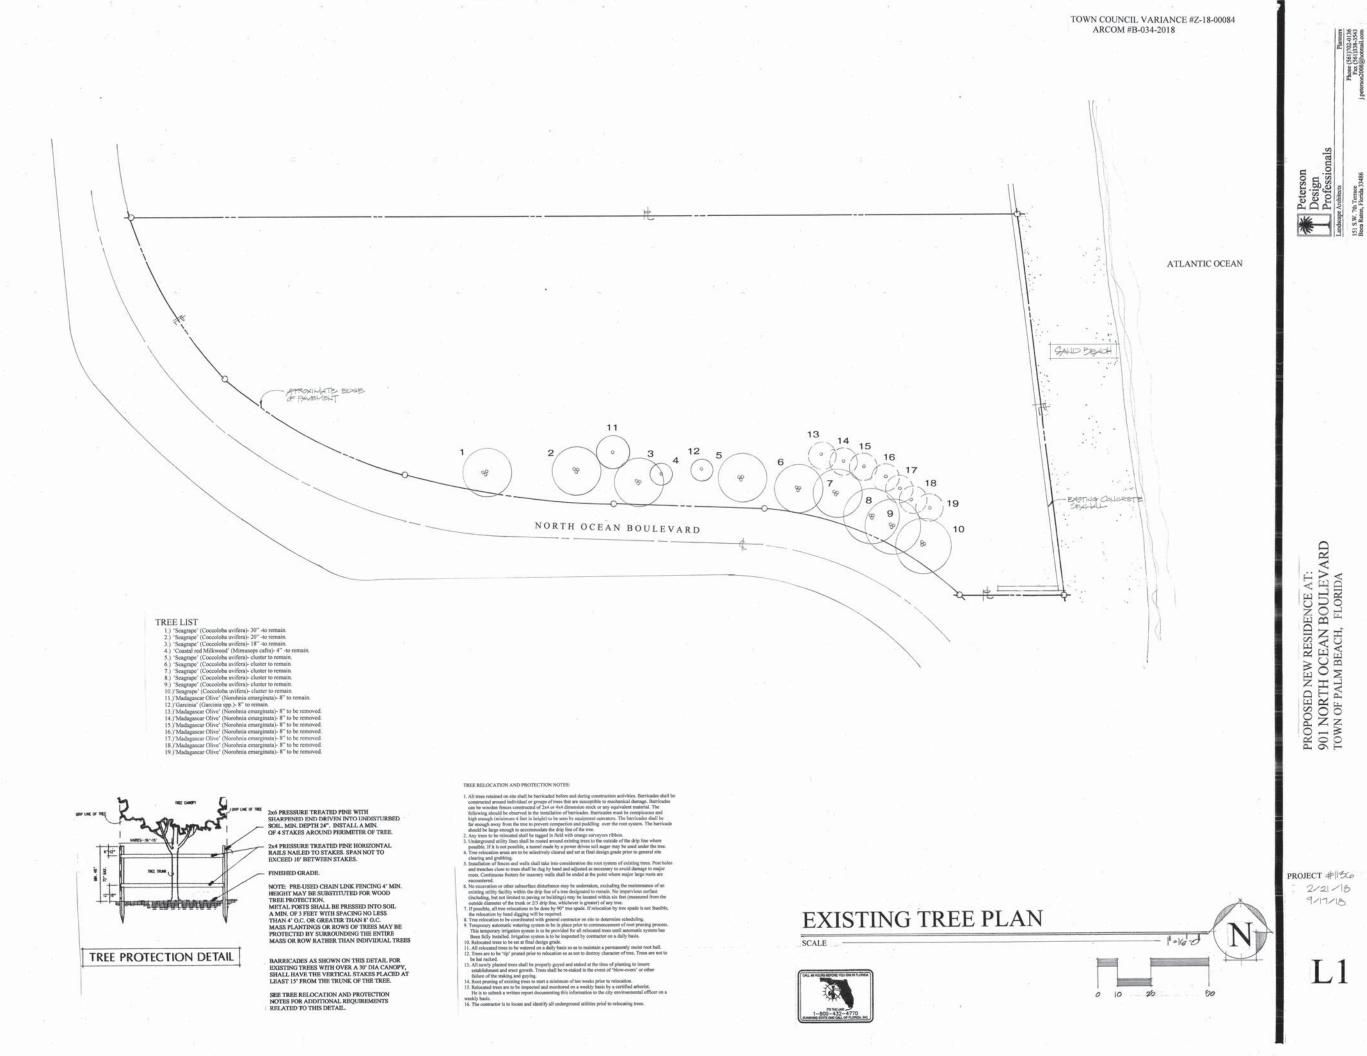




LANDSCAPE CALCULATIONS

ZONEDRA	
TOTAL SITE AREA50,020 SQ.FT.	
REQUIRED LANDSCAPE AREA(50%): 25,010 SQ.FT.	
LANDSCAPE AREA PROVIDED(58%): 29,223 SQ.FT.	
FRONT YARD AREA25,210 SQ.FT.	
FRONT LANDSCAPE SPACE REQUIRED(45%):11,255 SQ.FT.	
FRONT LANDSCAPE SPACE PROVIDED(52%):13174 SQ.FT.	


LANDSCAPE PLAN

SCALE -

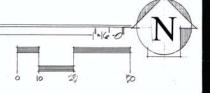

PROJECT #196


 L_2

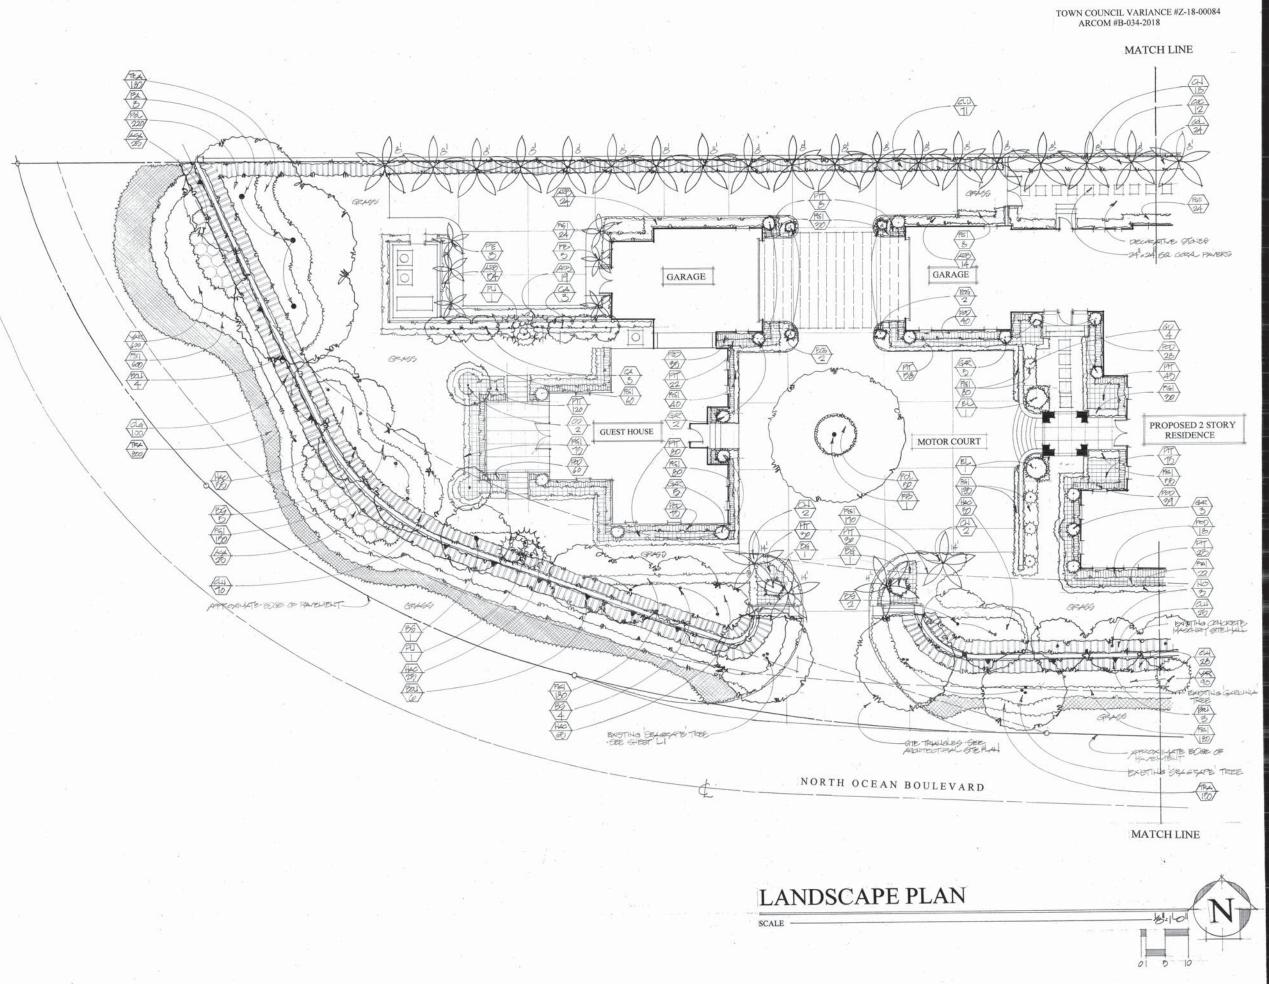

| Peterson | Design | Design | Professionals | Professionals | Planner | Pla


PROPOSED NEW RESIDENCE AT: 901 NORTH OCEAN BOULEVARD TOWN OF PALM BEACH, FLORIDA


PROJECT #1156

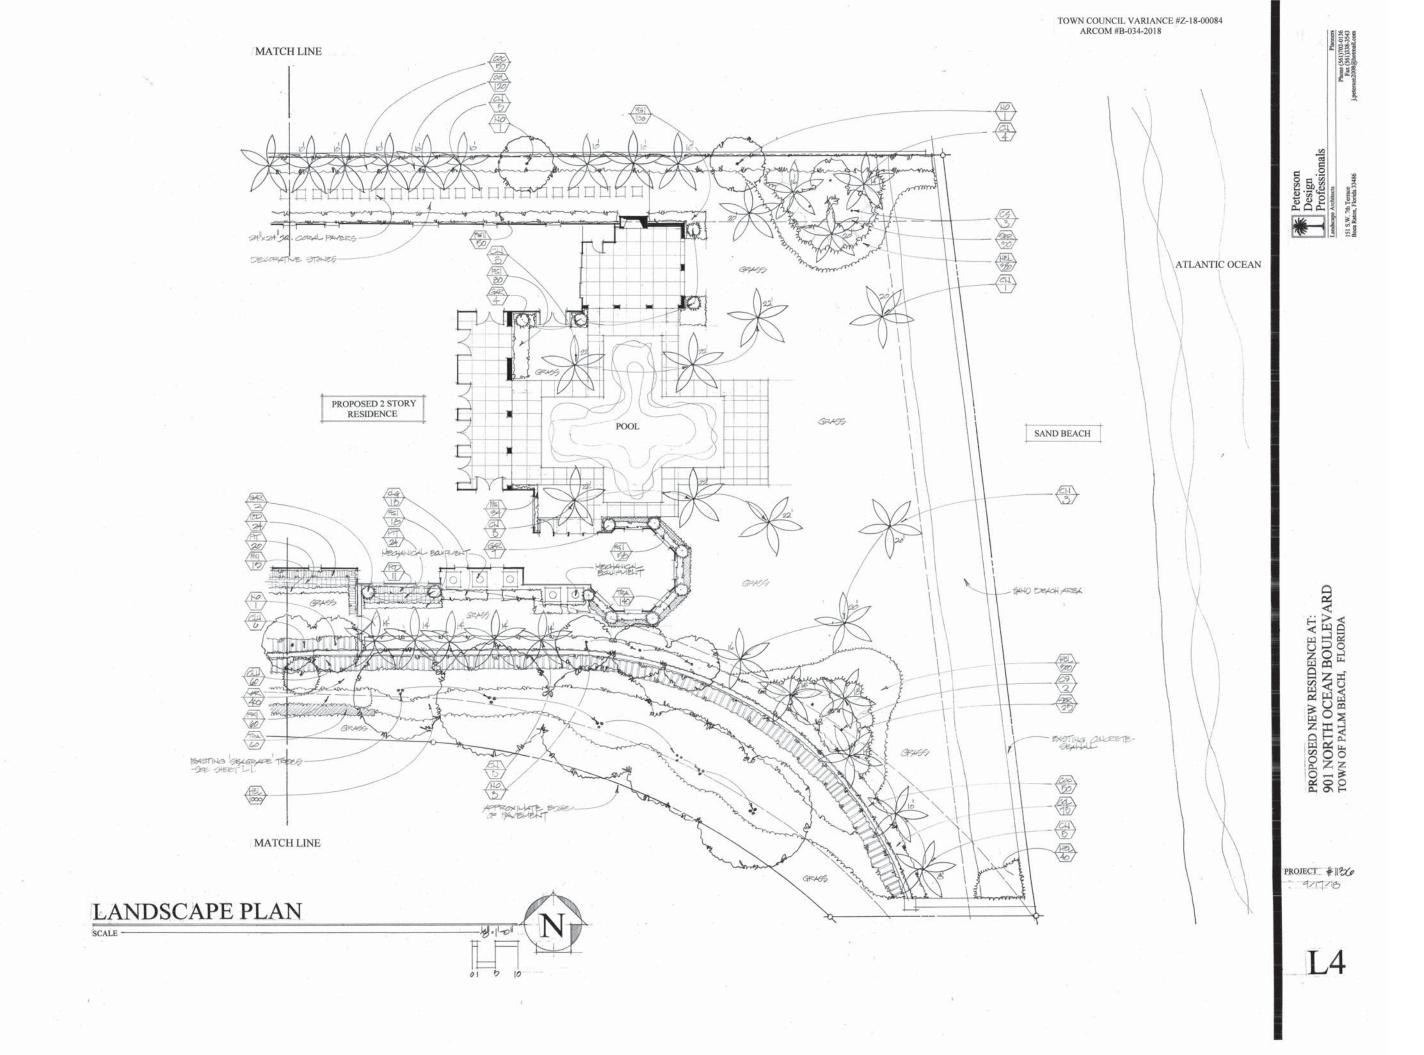


PLANTLIST

LEANT LIST			
SYM BOTANICAL NAME FA FICUS AUREUS-	COMMON NAME	SPECIFICATIONS	QUAN
FA FICUS AUREUS-	'STRANGLER FIG'	24' o.a. hgt	3
FB FICUS BENGHALENSIS-	'BANYAN TREE"	20' x16'	1
BS BURSERA SIMARUBA-	'GUMBO LIMBO'-	16' min. hgt, 14' min. spr	12
CN COCOS NUCIFERA- 'CC	CONUT PALM'- curv	ed trunks. Trunk hets on ol	an51
CA CALOPHYLLUM BRASI	LIENSIS- BEAUTY I	EAF'- 12' hgt	6
CD COCCOLOBA DIVERSIF	OLIA- 'PIDGEON PL	UM'- 14' het., 6' spr	2
PE PTYCHOSPERMA ELEGA	ANS- 'ALEXANDER I	ALM'- 6' grey wood	6
NO NORONHIA EMARGINA	TA- 'MADAGASCA	R OLIVE'- 14' het	9
PU PANDANUS UTILIS- 'SC	REW PINE'- 12' het		2
CS CONOCARPUS ERECTUS	S 'SER' - 'SILVER BU	TTONWOOD'- 12' o.a. hg	. 8' spr 5
GD GARDENIA JASMINOID	IES- 'GARDENIA'-	15 gal	4
BG BOUGANVILLEA GLAB	RA- 'BOUGANVILLI	EA'- 45gal. 5' std. red	2
BOG BOUGANVILLEA GLA	BRA- 'BOUGANVILI	EA'- vine trailers, 10', mir	34
BOU BOUGANVILLEA GLA	BRA- 'BOUGANVILI	.EA'- vine trailers. 6' attacl	to wall13
ACA ACALYPHA WILKESIA	NA- 'COPPER LEAF'	- 7 gal. 24" hgt. Louisiana i	red50
EL ELAEOCARPUS DECIPIE	NS-'JAPANESE BLUI	EBERRY'- 10' narrow	2
POD PODOCARPUS MACRO	PHYLLUS 'MAKE- 4	0" hgt., 7 gal	330
COC COCCOLOBA UVIFERA	- 'SEAGRAPE'- 8'	hgt. full to base	112
COL COCCOLOBA UVIFERA	- 'SEAGRAPE'- 7 ga	I. 3* het	219
GAR GARCINIA- 5' hgt. colu CLU CLUSIA GUTIFERA- 'SY	mn		28
CLU CLUSIA GUTIFERA- 'SN	MALL LEAF CLUSIA	'- 5' hgt. 25 gal	260
CLG CLUSIA GUTTIFERA- 'S	SMALL LEAF CLUSE	A'- 30" hgt	118
SER SERENOA REPENS- SA	W PALMETTO' - 7 gal	. 30" x 30"	55
ARB ARBORICOLA BRASSI	FLORA- 'ARBORICO	DLA'- 7 gal. 30" hgt	111
VAR ARBORICOLA BRASSI	FLORA 'VAR' - 'VAR	. ARBORICOLA'- 3 gal. 1	6" hgt1090
PIT PITTOSPORUM TOBIRA	'VAR"- 'VARIEGAT	ED PITTOSPORUM'- 3 gg	1540
HAC HAMELIA PATENS CO!	MPACTA- 'DWARF F	IREBUSH'- 3 gal	195
FGI FICUS 'GREEN ISLAND	- 'GREEN ISLAND F	ICUS'- 3 gal. 12" hgt	2282
FGII FICUS 'GREEN ISLAND	'- 'GREEN ISLAND F	ICUS'- 7 gal, 18" hgt	74
POL POLYSORUM SCOLOPI	ENDRIUM- WART FI	ERN'- 1 gal	270
TRA TRACHELOSPERMUM	ASIATICUM- 'DWAI	RF JASMINE'- 1 gal	1330
HEL HELIANTHUS DIBILIS-	'BEACH SUNFLOW!	ER'- 1 gal	1720

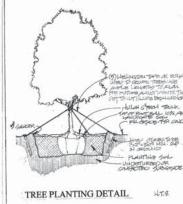

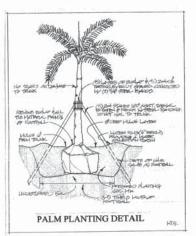

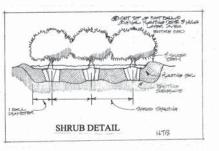

TREE PROTECTION DETAIL

TOWN COUNCIL VARIANCE #Z-18-00084 ARCOM #B-034-2018

- ARCOM #B-034-2018

 NOTES:

 1. ALL LANDSCAPING AND SPECIFICATIONS SHALL MEET OR EXCEED THE MINIMUM REQUIREMENTS AS PROVIDED IN THE PLANT LIST AND THE TOWN OF PALM BEACH LANDSCAPE CODE.

 2. ALL PLANTING MATERIAL SHALL MEET OR EXCEED FLORIDA GRADE #1 AS SPECIFIED IN 'GRADES AND STANDARDS FOR NURSERY PLANTS; AND PART ? "PALMS AND TREES; CURRENT EDITION. TREES TO BE INSTALLED SHALL NOT BE TIPPED, TOPPED, OR SHAPED PRIOR TO INSTALLATION.

 3. THE CONTRACTOR IS RESPONSIBLE FOR REPAIRING ANY OR ALL FACILITIES DAMAGED AND IS TO COORDINATE WITH ALL OTHER CONTRACTORS ON SITE.

 4. PLANTING SOIL IS TO BE WEED FREE MIXTURE OF MUCK AND SAND (30-70) WITH 50 LBS OF MILORGANITE PER 6 CU. YDS.

 5. APPL 3" "GOLD" CYPRESS MULCH AROUND ALL PLANTS WITHIN 2 DAYS.

 6. ALL SODDED AREAS ARE TO BE COVERED WITH 'EMPIRE ZOYSIA' SOD, EXCEPT WHERE NOTED. SOD TO HAVE GOOD COMPACT GROWTH AND ROOT SYSTEM LAY WITH TIGHT JOINTS.

 7. GUYING! STAKING PRACTICES SHALLINGT PERMIT NAILS, SCREWS, WIRES, ETC... TO PENETRATE OUTES SURFACES OF TREES, PALMS, OR OTHER PLANT MATERIAL. TREES, PALMS, AND PLANT MATERIAL REJECTED DUE TO THIS PRACTICES ISHALL REPLACED WITH THE INSPECTOR ON SITE.

 8. BURLAP MATERIAL, WIRE CAGES, PLASTIC CANVAS STRAPS, ETC... MUST BE CUT AND REMOVED FROM THE TOP ONE HALF DEPTH OF THE ROOT BALL TREES AND SITEMS GROWN IN GROW BAGS OR GROW BAG TYPE MATERIAL MUST HAVE SUCH MATERIAL. REMOVED ENTIFIEL YRICH SON GROW BAGS OR GROW BAG TYPE MATERIAL MUST HAVE SUCH MATERIAL. REMOVED ENTIFIELY PRIOR TO PLANTING THE TREE OF SHRUB.

 9. ALL PLANT MATERIAL SHALL BE PLANTED AT THE PROPER DEPTH AS ORGINALLY OR OWN AND OR SO THE TOP ON THE ROOT BALL IS FROM THE PROPER DEPTH AS ORGINALLY OR OWN AND OR SO THE TOP ON THE ROOT BALL IS FLUSH OR SLIGHTLY A BRED PROPER DEPTH AS ORGINALLY OR OWN AND OR SO THE TOP OT THE ROOT BALL IS FLUSH OR SLIGHTLY A BRED FROM THE TOP ON THE ROOT BALL IS FLUSH OR SLIGHTLY A BRED FROM THE TOP OT THE ROOT BALL IS FLUSH OR SLIGHTLY A BRED FROM THE PROPER DEPTH AS ORGINALLY OR OWN AND OR SO THE TOP OT THE ROOT BALL IS FLUSH OR S

- OR OTHER LANDS.

 14. SITE DISTANCE CONCERNS MUST BE MAINTAINED FOR CLEAR SITE VISIBILITY FROM THIRTY INCHES TO SEVENTY-TWO INCHES, TREE TRINKS EXCLUDED. MEASUREMENT SHALL BE MADE FROM TOP OF ROOT BALL PLANTED AT PROPER ELEVATION.

 15. UPON COMPLETION OF WORK, THE SITE SHALL BE CLEARED OF ALL DEBRIS, SUPERFLUOUSE MATERIALS, AND EQUIPMENT CAUSED BY THIS FERMIT TO THE SATISFACTION OF THE INSPECTOR.

 16. SEE PLANTING DETAILS FOR ADDITIONAL PLANTING INFORMATION.

 17. LANDSCAPE CONTRACTOR TO PROVIDE AN AUTOMATIC UNDERGROUNDIRRIGATION SYSTEM, AS EVON ON PLANS. SYSTEM SHALL HAVE A RAIN SENSOR SEVICE AS REQUIRED. THERE SHALL BE NO OVERSPRAY ON SIDEWALKS OR ON ROADWAYS. SYSTEM SHALL HAVE A RAIN SENSOR SO ON ROADWAYS. SYSTEM SHALL HAVE A RAIN SENSOR SO ON ROADWAYS.

 18. ALL CONSTRUCTION ON SOVERAND FOREIGN MATTER SHALL BE REMOVED SHOW OF PLANTEN SHALL BE REMOVED SHOW OF PLANTEN SHALL BE REMOVED OF ANY CHANGES FOR APPROVAL IN PLANT MATERIAL PRIOR TO DESTAILATION.

 19. THE LANDSCAPE ARCHITECT AND THE TOWN OF PLAN BEACH SHALL AND CAPE ARCHITECT AND THE TOWN OF PLAN BEACH MATERIAL PRIOR TO DISTALLATION.

 20. ALL LANDSCAPE CONTRACTOR SHALL CONTACT THE COUNTY, TOWN, AND/OR UTILITY COMPANIES TO LOCATE ALL UNDERGROUND UTILITIES OR STRUCTURES PRIOR TO DIGIGING. THE LANDSCAPE CONTRACTOR SHALL CONTACT THE COUNTY, TOWN, AND/OR UTILITY COMPANIES TO LOCATE ALL UNDERGROUND UTILITIES OR STRUCTURES PRIOR TO DIGGING. THE LANDSCAPE CONTRACTOR SHALL BE FAR ALL DAMAGE TO UNDERGROUND UTILITIES OR STRUCTURES PRIOR TO CAUSED AT NO COST TO THE OWNER.

 2. ALL PLANT MATERIAL SHALL BE GUARANTEED FOR A PERIOD OF 12 MONTHS AFTER DATE OF SUBSTIANTIAL COMPLETION.

 2. IN ADDITION TO THESE REQUIREMENTS, ALL LOCAL LANDSCAPE CODES SHALL BE MET IN ORDER TO SATISFY THE REVIEW AND APPROVAL OF THE GOVERNING MUNICIPALITY.

 24. CO-ORDINATE WITH ALL TRADES, ESPECIALLY THE IRRIGATION CONTRACTOR.


PROPOSED NEW RESIDENCE AT: 901 NORTH OCEAN BOULEV TOWN OF PALM BEACH, FLORIDA

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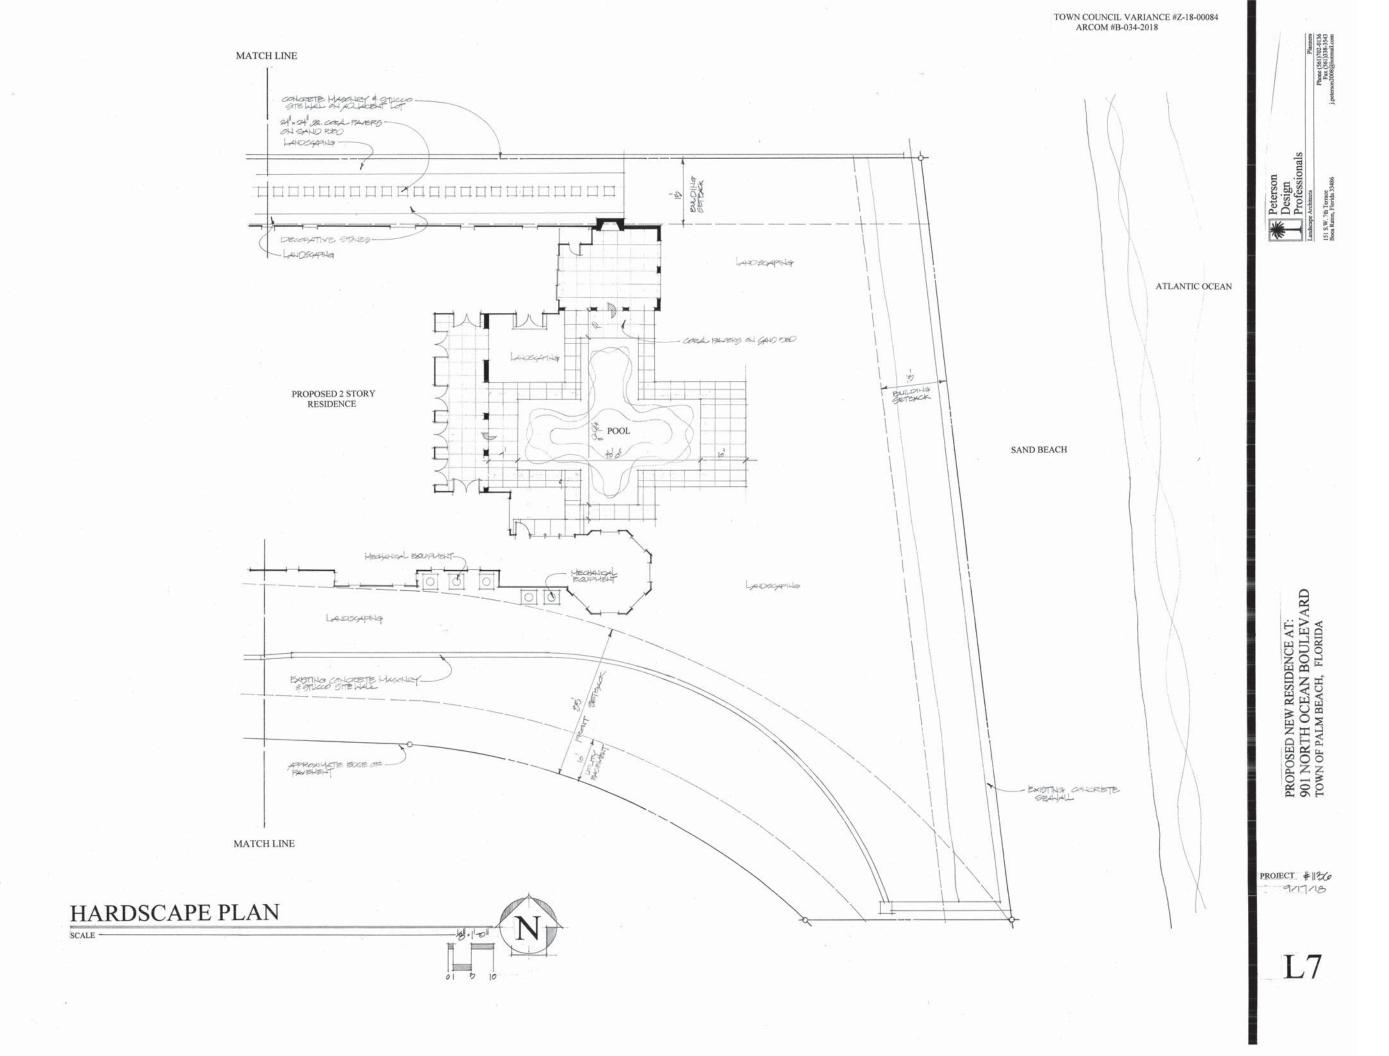
| Peterson | Design | Professionals


PROJECT #119% 9/17/18




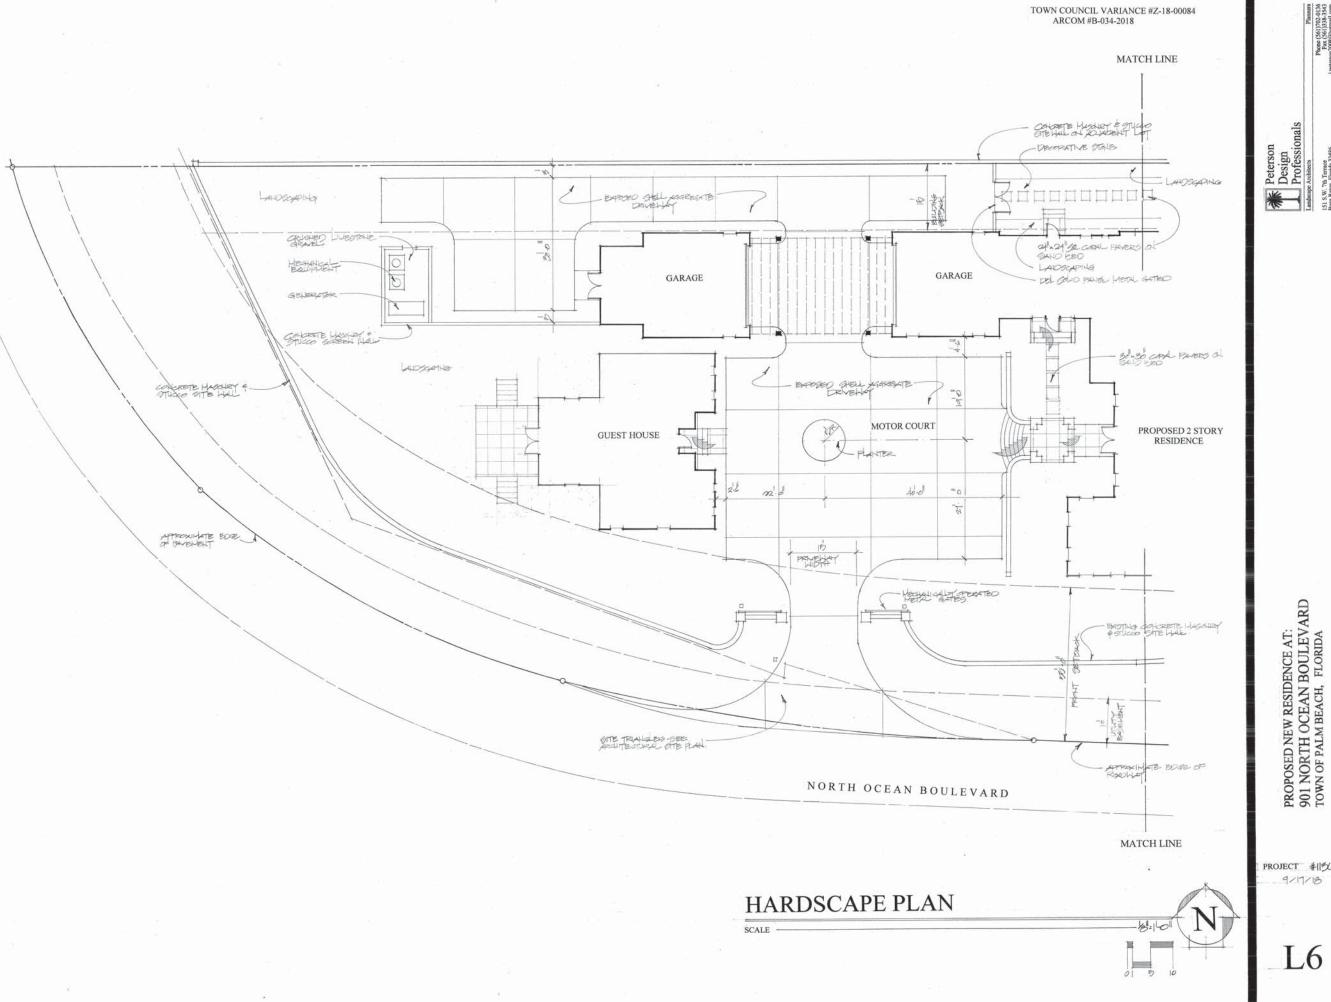

PROJECT #1156 9/17/18



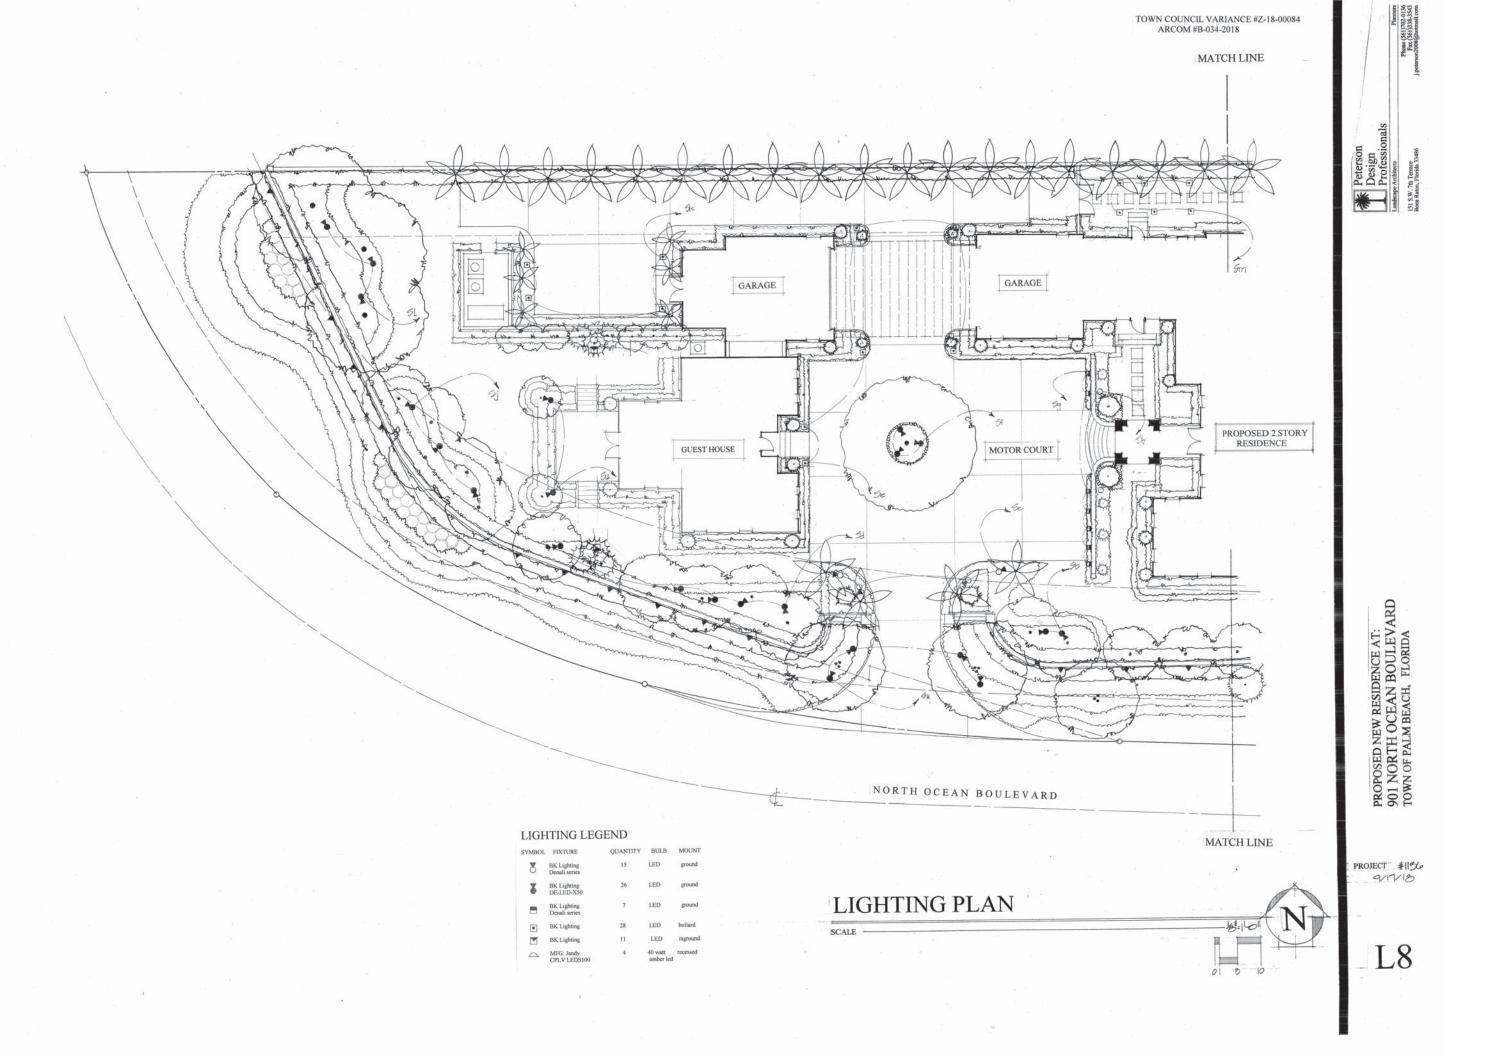


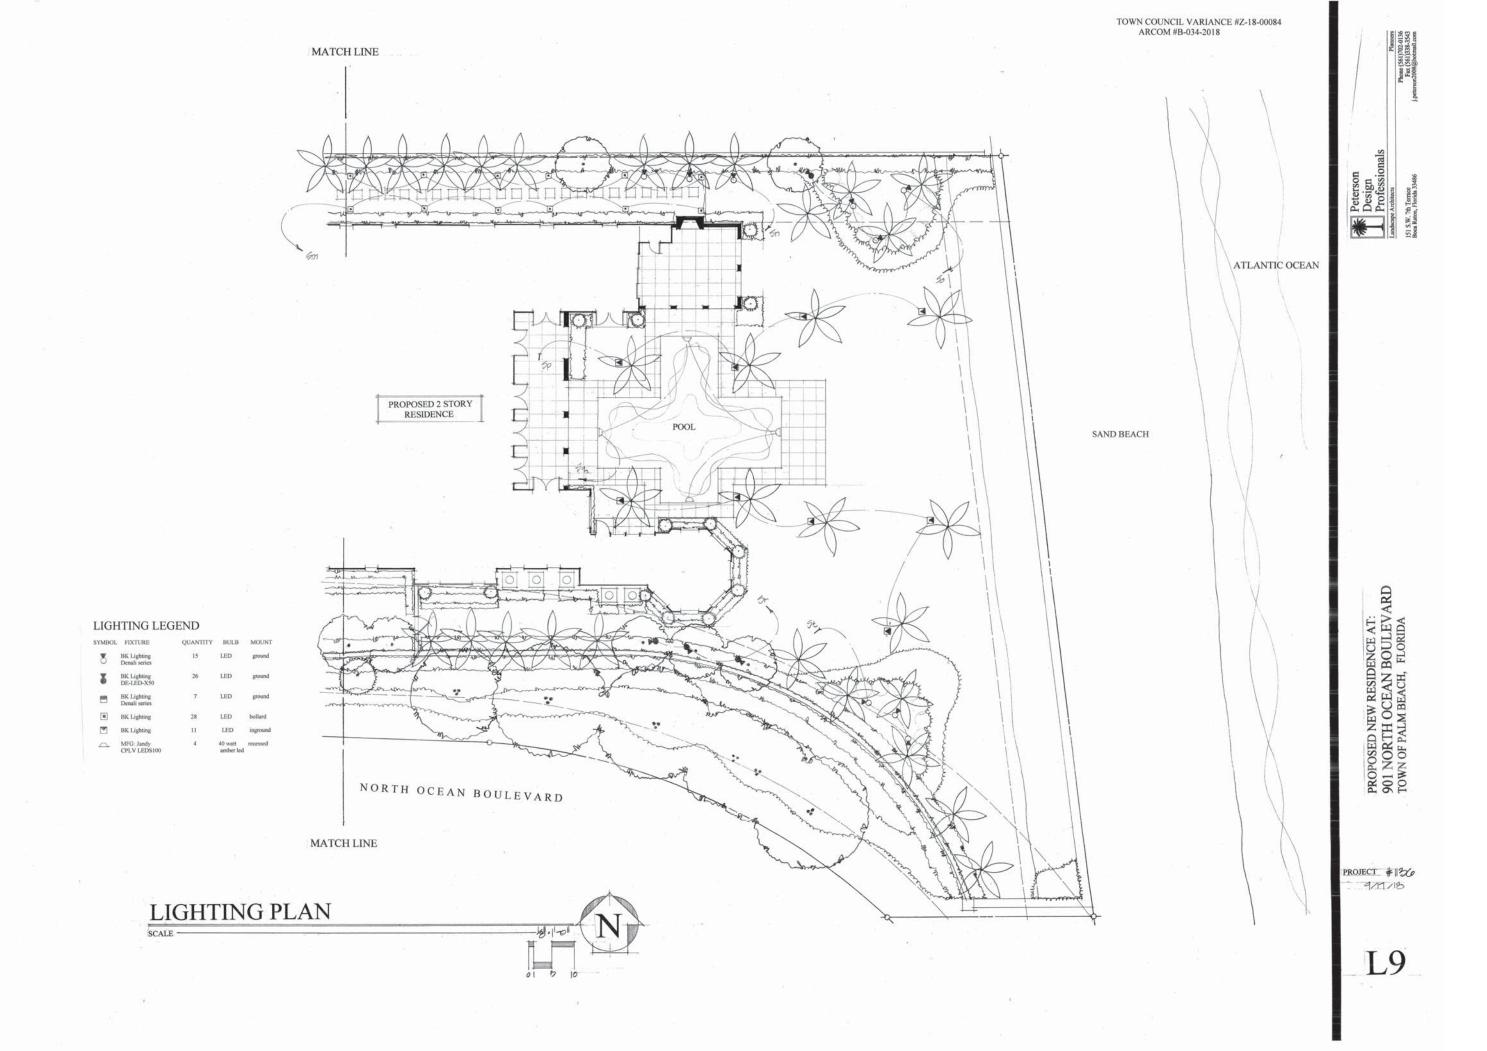

MATCH LINE

MATCH LINE

SOUTH ELEVATION

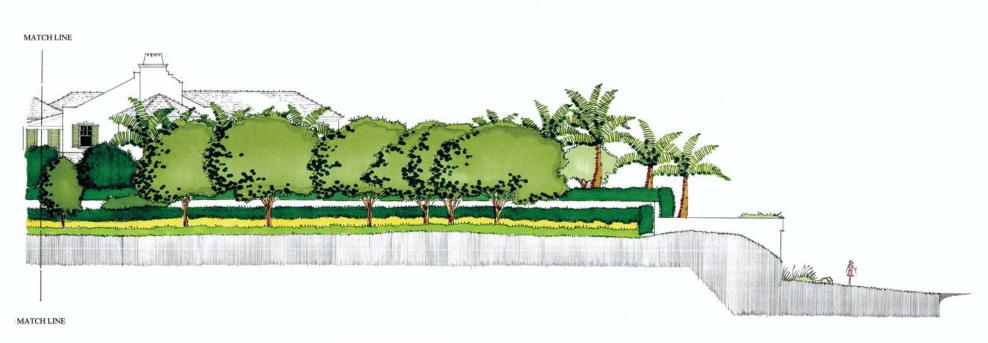


SOUTH ELEVATION

PROPOSED NEW RESIDENCE AT: 901 NORTH OCEAN BOULEVARD TOWN OF PALM BEACH, FLORIDA

PROJECT #1186 9/17/18

MATCH LINE

NORTH ELEVATION

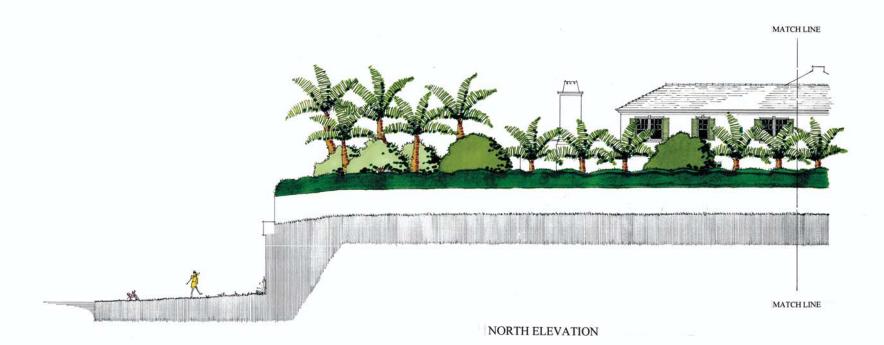


MATCH LINE

PROJECT #1156

PROPOSED NEW RESIDENCE AT: 901 NORTH OCEAN BOULEVARD TOWN OF PALM BEACH, FLORIDA

9/17/18

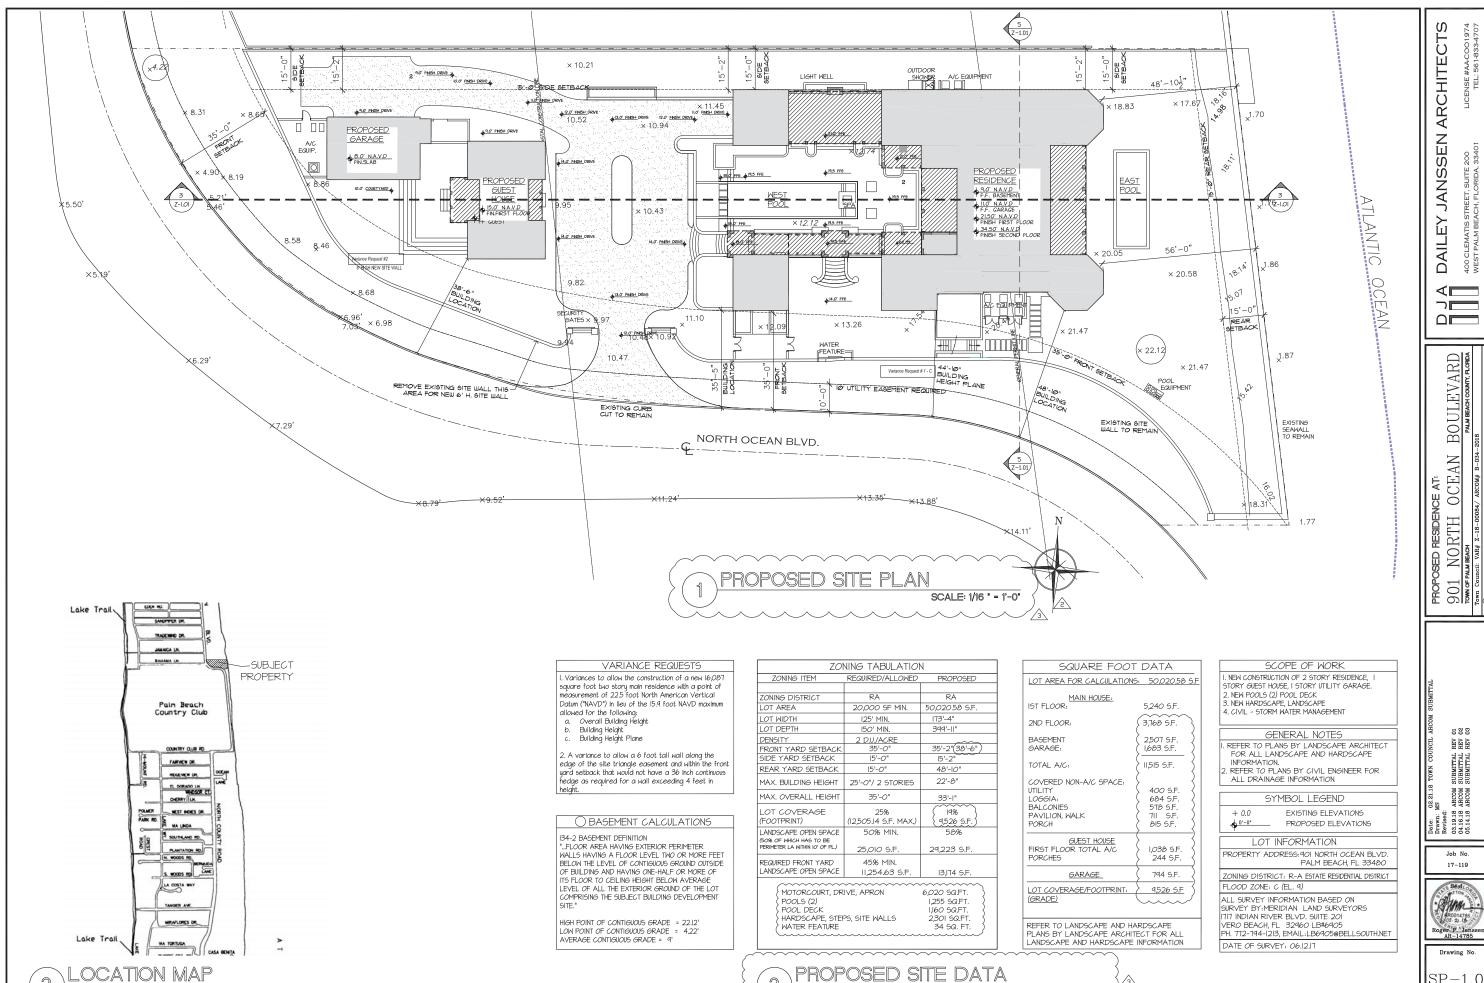

N.T.S.


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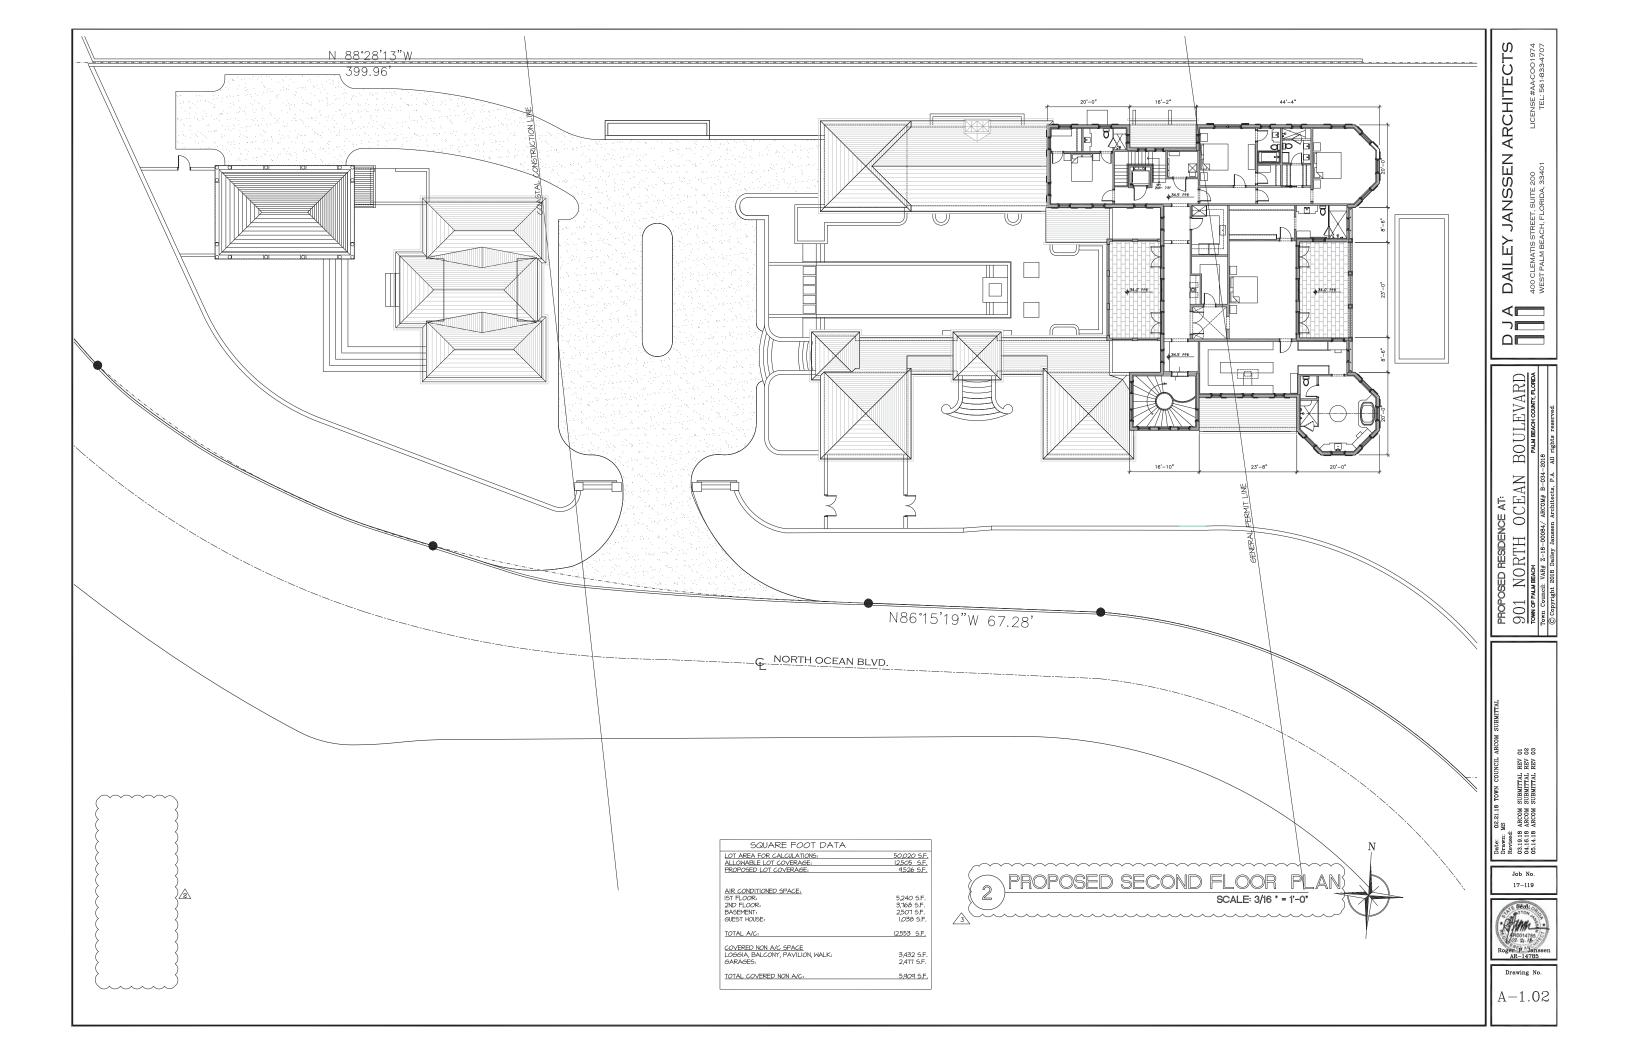
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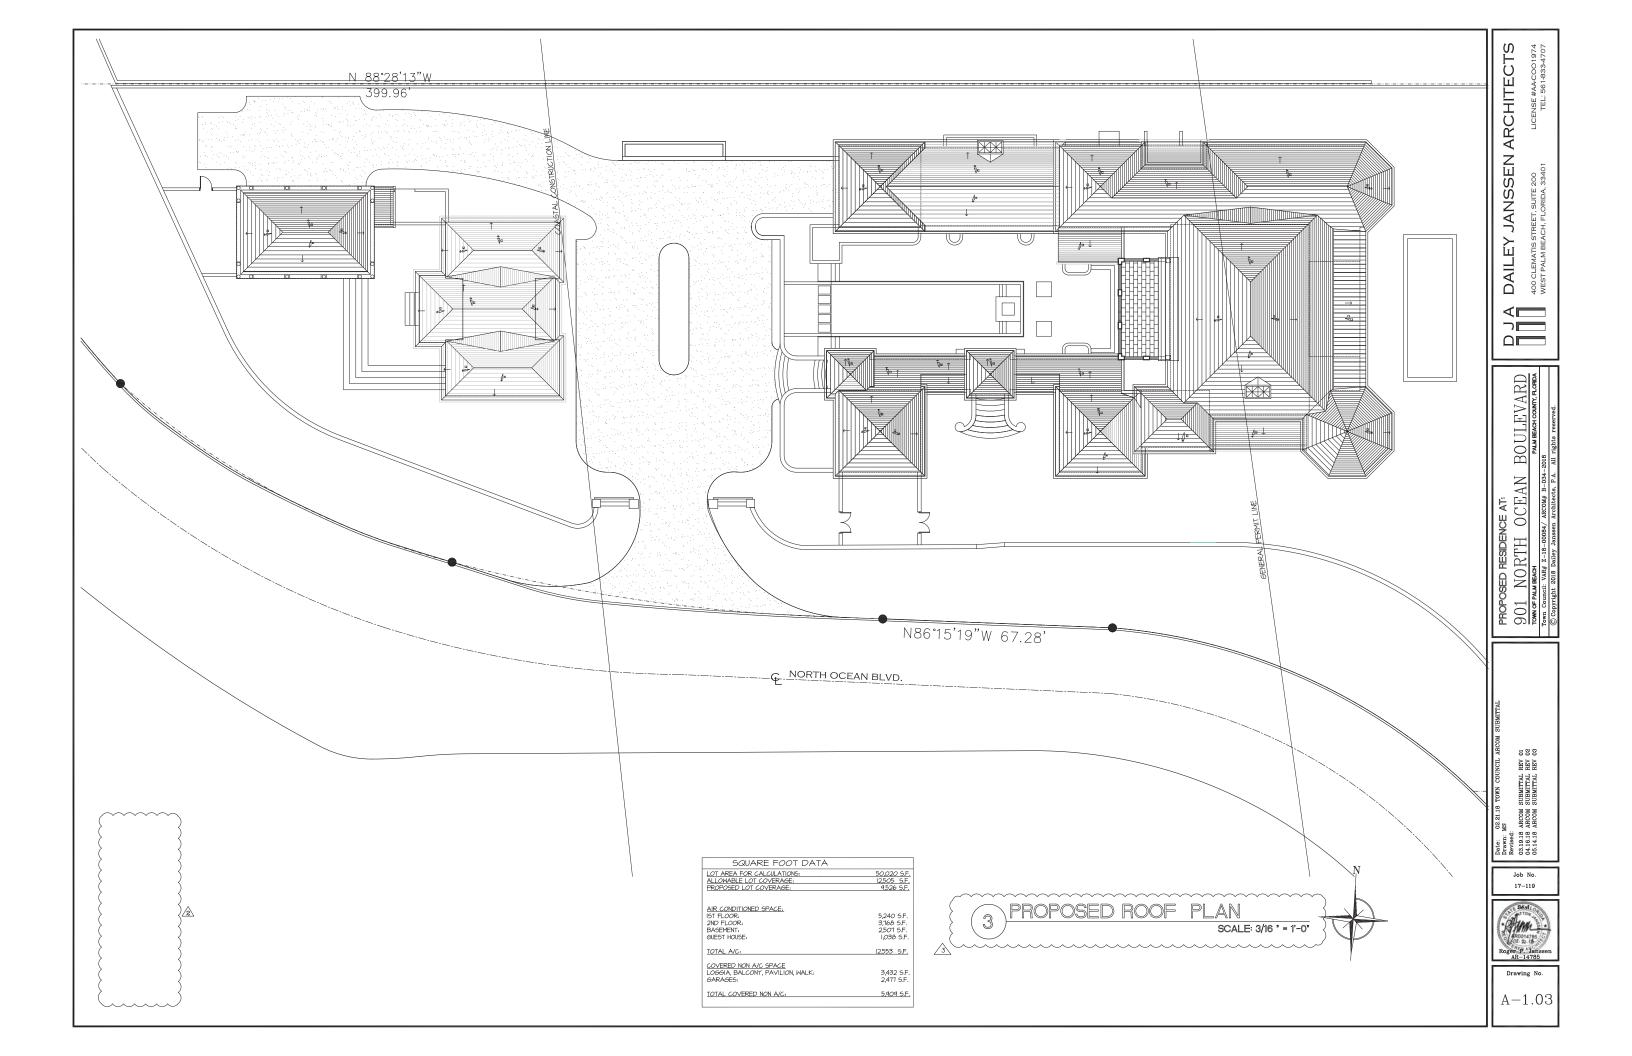
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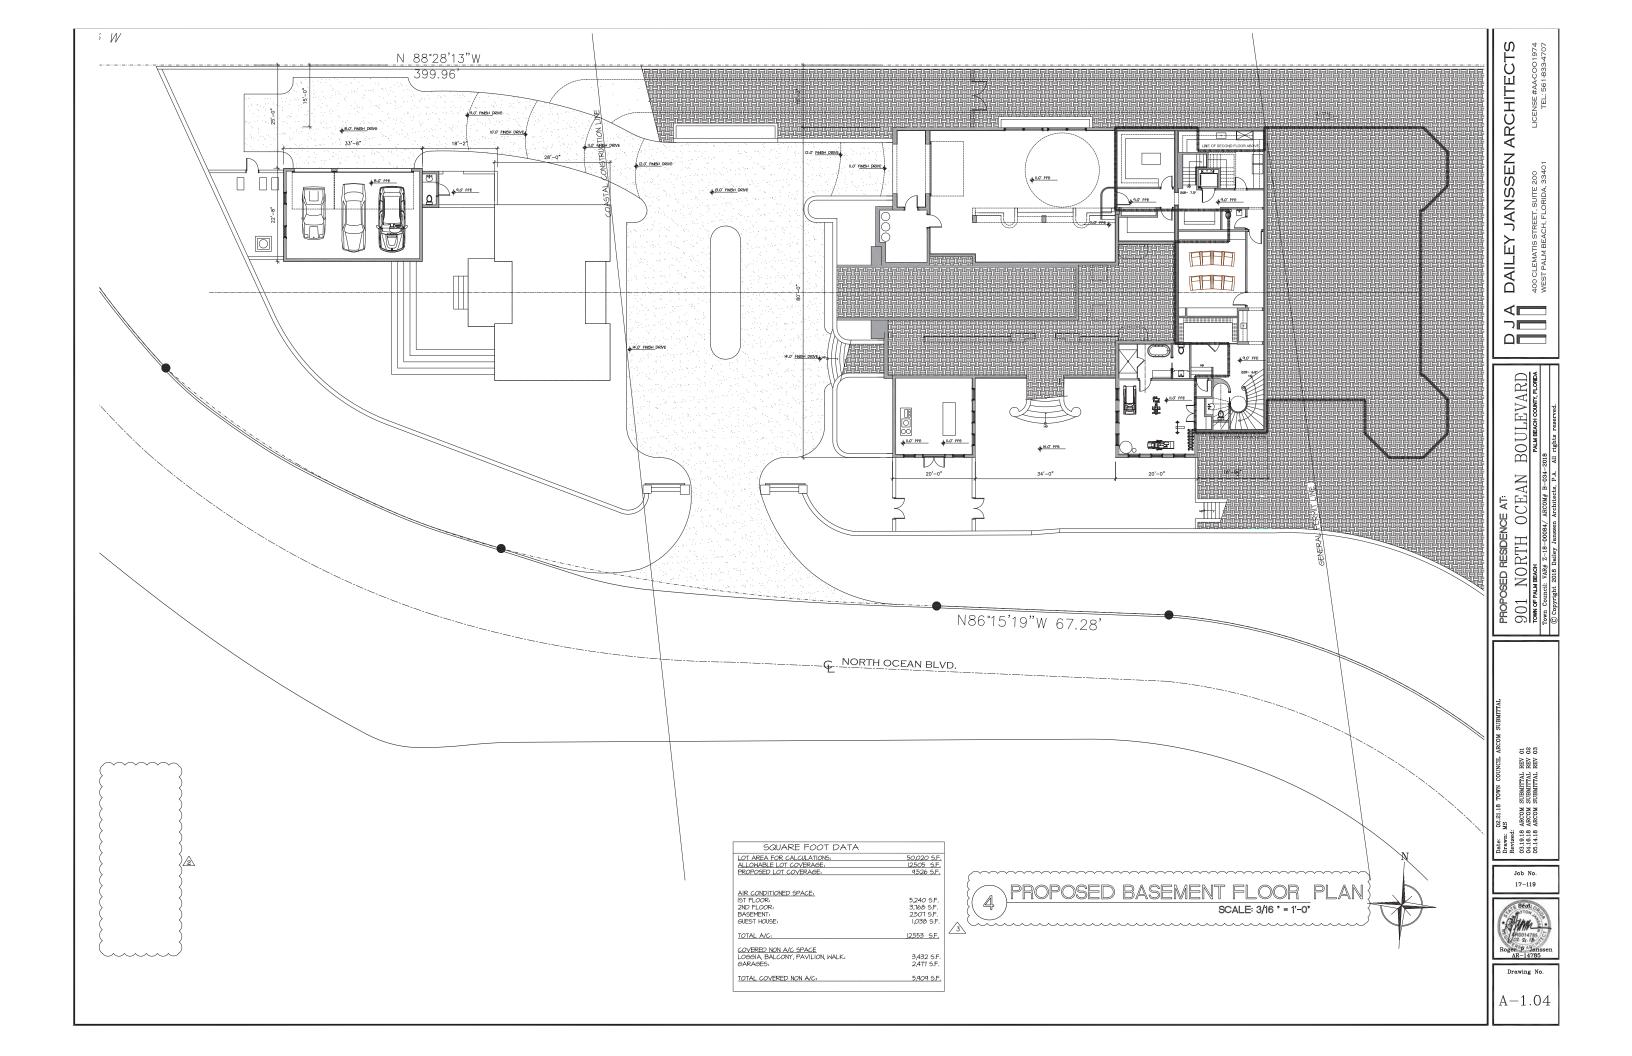
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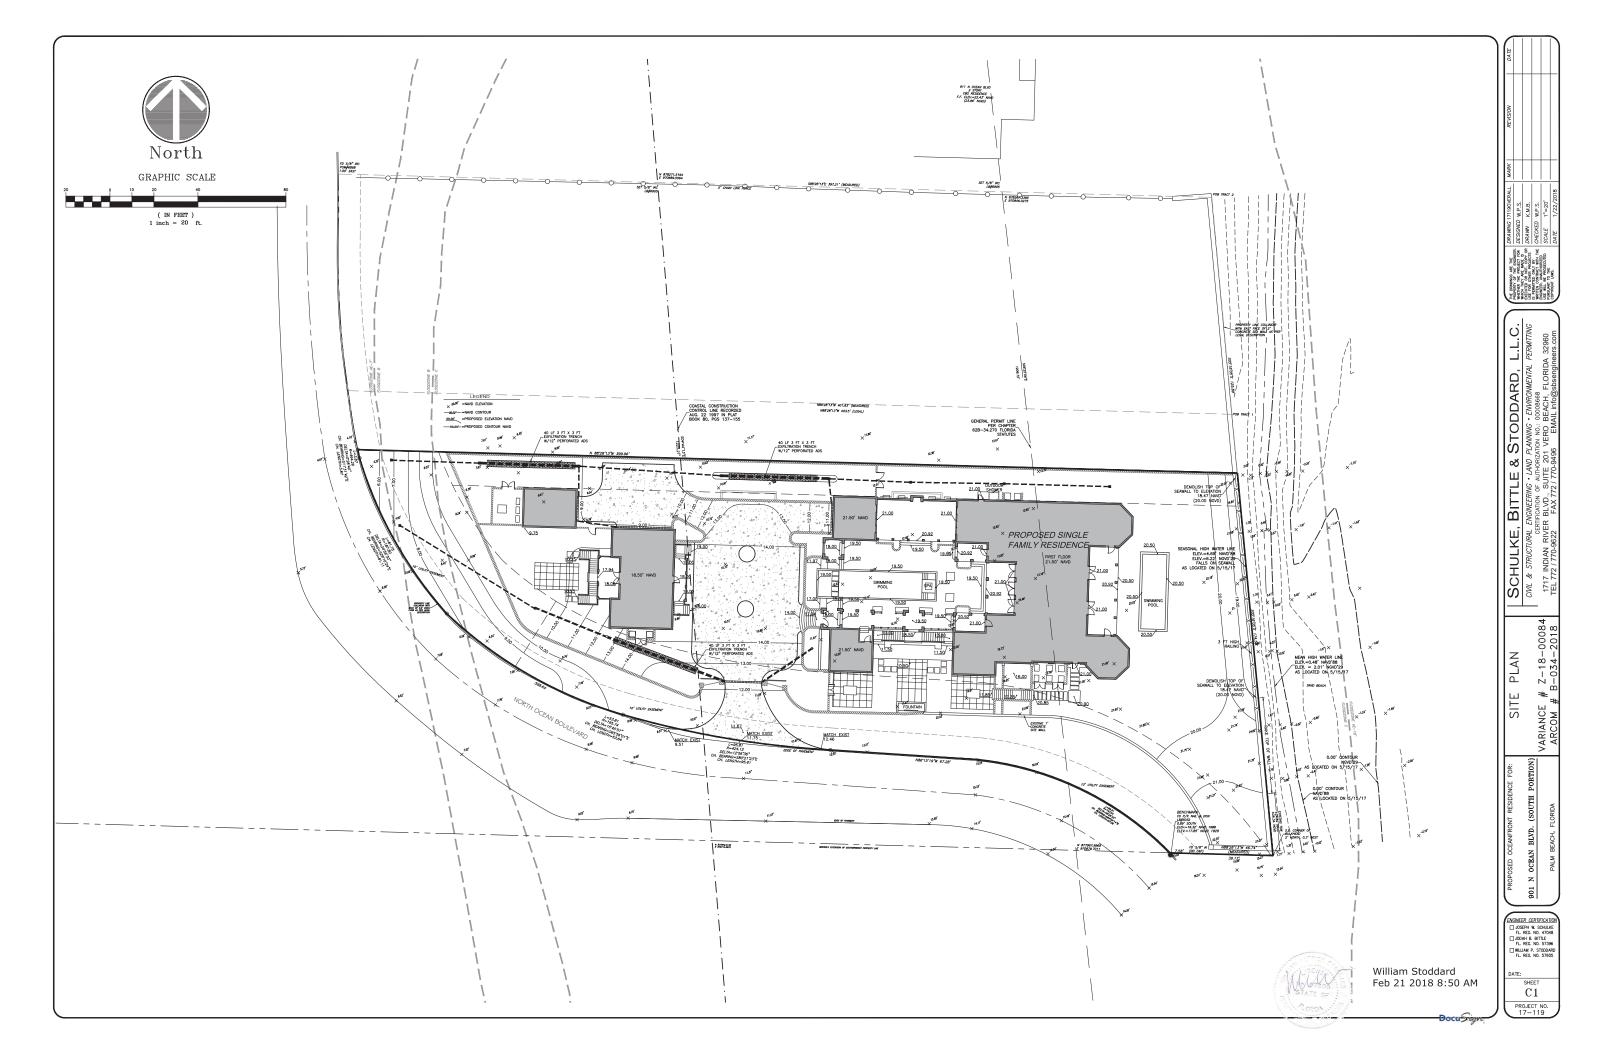
N.T.S.









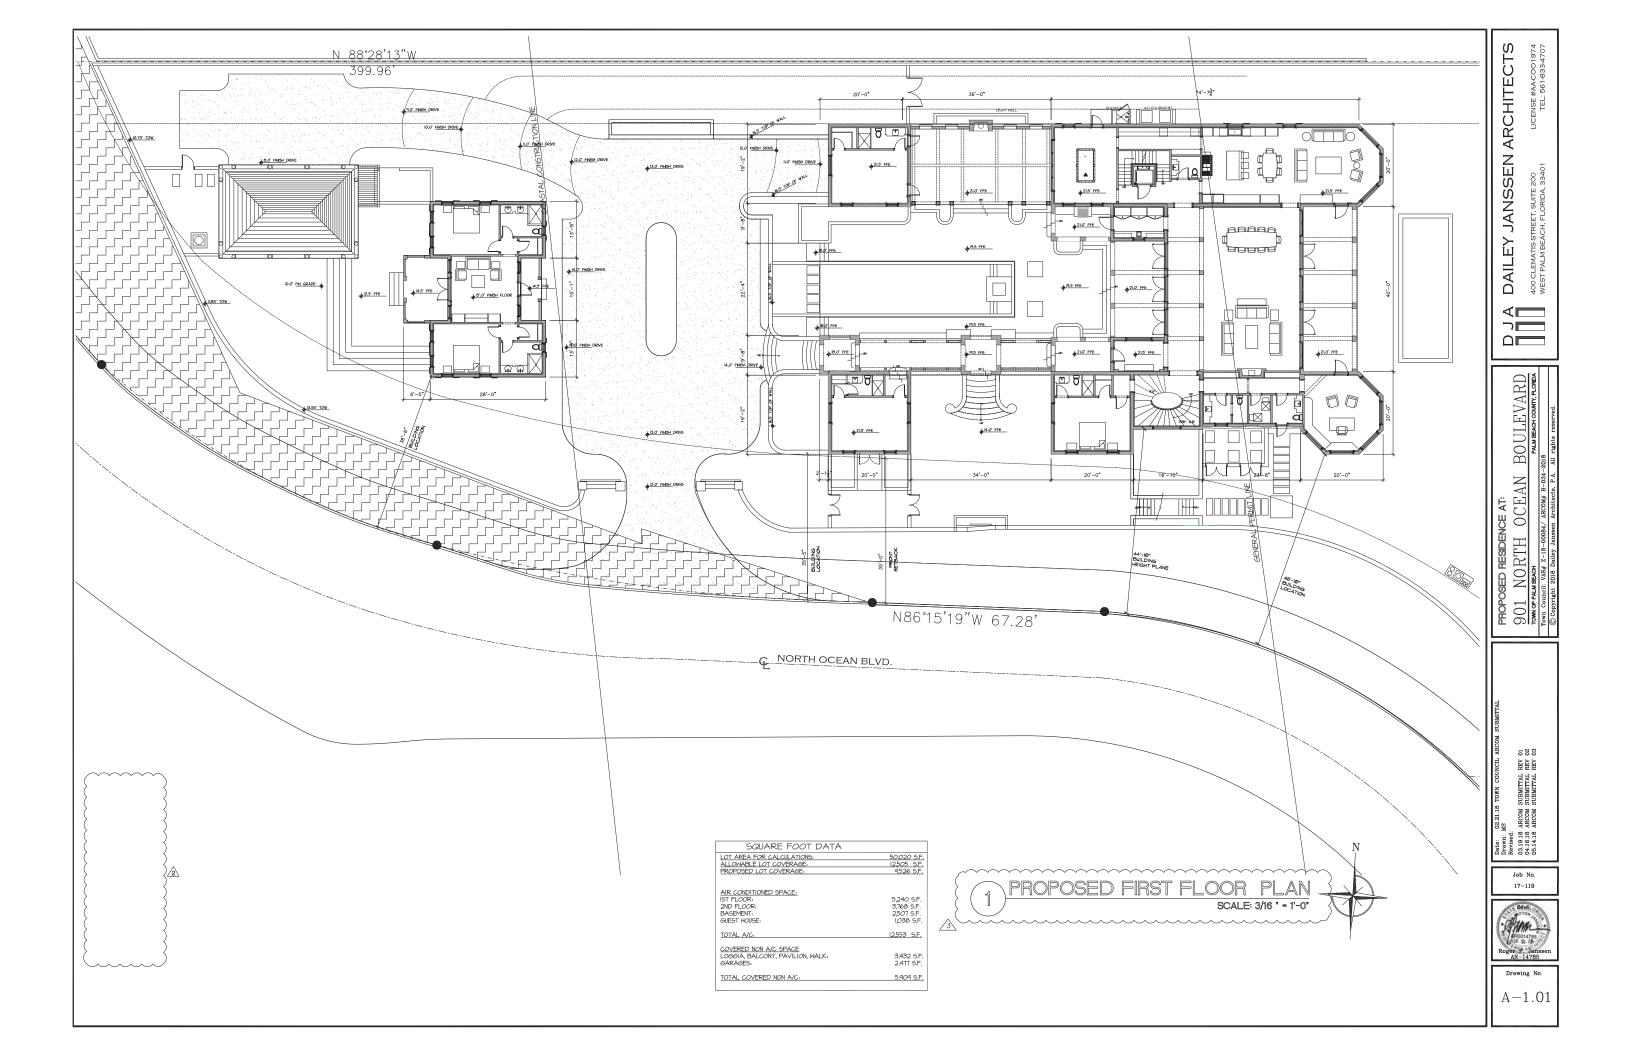

LEGAL DESCRIPTION: PARCEL 2

A TRACT OF LAND LYING AND BEING IN SECTION 10 AND 11, TOWNSHIP 43 SOUTH, RANGE 43 EAST, TOWN OF PALM BEACH, PALM BEACH COUNTY, FLORIDA AND MORE PARTICULARLY DESCRIBED AS FOLLOWS:

COMMENCE AT THE NORTHEAST CORNER OF THOSE LANDS DESCRIBED IN OFFICIAL RECORDS BOOK 28125, PAGE 123, PUBLIC RECORDS OF PALM BEACH COUNTY, FLORIDA:

THENCE RUN SOUTH 05°18'05" EAST (BASIS OF BEARINGS) ALONG THE EAST FACE OF AN THENCE RUN SOUTH 65°18'05° EAST (BASIS OF BEARINGS) ALONG THE EAST FACE OF AN EXISTING SEAWALL, A DISTANCE OF 125.89 FEET TO THE TRUE POINT OF BEGINNING; THENCE CONTINUE SOUTH 65°18'05° EAST, A DISTANCE OF 174.58 FEET; THENCE LEAVING SAID FACE OF WALL, RUN NORTH 88'228'13" WEST, A DISTANCE OF 46.74 FEET MORE OR LESS TO THE EAST FACE OF CURB AS NOW LAID OUT, SAID LINE ALSO BEING THE EAST RIGHT OF WAY LINE OF OCEAN BOULEVARD, SAID POINT ALSO BEING A POINT ON A NON-TANGENT CURVE, CONCAVE TO THE SOUTHWEST, THE RADIUS OF WHICH BEARS SOUTH 45'38'31" WEST, A DISTANCE OF 143.64 FEET; THENCE RUN NORTHWESTERLY ALONG THE ABOL OF SAID CURVE AND BOKY OF CURPT THEOLOGY. ALONG THE ARC OF SAID CURVE AND BACK OF CURB THROUGH A CENTRAL ANGLE OF 39°29'30". AN ARC DISTANCE OF 99.01 FEET: THENCE RUN ON A NON-TANGENT LINE NORTH 86°15'19" WEST, A DISTANCE OF 67.28 FEET TO A POINT ON A NON-TANGENT CURVE 86°15'19' WEST, A DISTANCE OF 67.28 FEET TO A POINT ON A NON-TANGENT CURVE, CONCAVE TO THE NORTHEAST, THE RADIUS OF WHICH BEARS NORTH 03°10'19' EAST, A DISTANCE OF 424.12 FEET, THENCE RUN NORTHWESTERLY ALONG THE ARC OF SAID CURVE AND BACK OF CURB THROUGH A CENTRAL ANGLE OF 12°56'39', AN ARC DISTANCE OF 95.81 FEET TO A POINT OF NON-TANGENT COMPOUND CURVAUTURE OF A CURVE CONCAVE TO THE NORTHEAST, THE RADIUS OF WHICH BEARS NORTH 16°11'25' EAST, A DISTANCE OF 195.74 FEET, THENCE RUN NORTHWESTERLY ALONG THE ARC OF SAID CURVE, THROUGH A CENTRAL ANGLE OF 2°7'16'46', AN ARC DISTANCE OF 93.19 FEET TO A POINT OF NON-TANGENT COMPOUND CURVATURE OF A CURVE CONCAVE TO THE NORTHEAST. THE RADIUS OF BARS NORTH 18°21'57'15' EAST, A DISTANCE OF 195.74 FEET, THENCE OF BARS NORTH 18°21'57'15' EAST, A DISTANCE OF 18°2. 19 FEET TO A POINT OF NON-TANGENT COMPOUND CURVATURE OF A CURVE CONCAVE TO THE NORTHEAST, THE RADIUS OF WHICH BEARS NORTH 48°15'21" EAST, A DISTANCE OF 187.80 FEET: THENCE RUN NORTHERLY ALONG THE ARC OF SAID CURVE THROUGH A CENTRAL FEET; THENCE RUN NORTHERLY ALONG THE ARC OF SAID CURVE THROUGH A CENTRAL ANGLE OF 24'56'09', AN ARC DISTANCE OF 81.75 FEET TO A POINT OF NON-TANGENT COMPOUND CURVATURE OF A CURVE CONCAVE TO THE EAST, THE RADIUS OF WHICH BEARS NORTH 78'13'58' EAST, A DISTANCE OF 484.26 FEET; THENCE RUN NORTHERLY ALONG THE ARC OF SAID CURVE THROUGH A CENTRAL ANGLE OF 00'28'40", AN ARC DISTANCE OF 3.87 FEET; THENCE LEAVING SAID CURVE AND BACK OF CURB RUN SOUTH 88'28'13" EAST, A DISTANCE OF 399.96 FEET MORE OR LESS TO THE POINT OF BEGINNING.

SAID PARCEL CONTAINING 50020 58 SQUARE FEET MORE OR LESS.

ALL OF THE ABOVE SUBJECT TO THAT PERPETUAL SITE TRIANGLE EASEMENT RECORDED IN OFFICIAL RECORD BOOK 29509, PAGE 1378 AND UTILITY EASEMENT RECORDED IN OFFICIAL RECORD BOOK 29509, PAGE 1407 OF THE PUBLIC RECORDS OF PALM BEACH COUNTY, FLORIDA.

x[23.5]

Legend & Abbreviations:
(symbols not scaleable for size)
PLS - PROFESSIONAL LAND SURVEY
PSM - PROFESSIONAL SURVEYOR R
LB - LAND SURVEYING BUSINESS
C - CENTEDING PROFESSIONAL LAND SURVEYOR PROFESSIONAL SURVEYOR & MAPPER LAND SURVEYING BUSINESS CENTERLINE RADIUS

DELTA ANGLE

DELIA ANGLE
EDGE OF PAVEMENT
BACK OF CURB
BENCHMARK
POINT OF COMMENCEMENT
POINT OF BEGINNING
(PCP) PERMANENT CONTROL POINT

(PRM) PERMANENT REFERENCE MONUMENT

(IRC) IRON ROD & CAP (CM) CONCRETE MONUMENT FOUND

CALCULATED

RIGHT OF WAY IDENTIFICATION SEA GRAPE CLUSTER W/ DIA.

BEACH DAISY CLUSTER W/ DIA

CABLE T.V. BOX ELECTRIC BOX LIGHT POST

WATER METER SANITARY MANHOLE SANITARY SERVICE

SEPTIC TANK
DRAINAGE MANHOLE
CURB INLET
SURFACE INLET
MITERED END SECTION CONCEPTUAL DRAINAGE STREET SIGN

23.5 NAVD x23.5 A/C CONC. PROPOSED GRADE
NORTH AMERICAN VERTICAL DATUM
TYPICAL NAVD ELEVATION

AIR CONDITIONER CONCRETE FINISH FLOOR BUILDING SETBACK LINI EL./ELEV. FLEVATION

NON-RADIAL

PINE TREE W/ DIAMETER

TYPICAL NGVD ELEVATION


NATIONAL GEODETIC VERTICAL DATUM

MANGROVE TREE W/ DIAMETER

COMMENCMENT— N.E. CORNER D.R.B. 28125, PAGE 123 _N 878267.3395 E 970846.0275 88'28'13"E 397.21' (MEASURE COASTAL CONSTRUCTION CONTROL LINE RECORDED AUG. 22 1997 IN PLAT BOOK 80, PGS 137-155 17.95 a X XX 0.03 PARCEL 1 (NOT INCLUDED) -POINT OF BEGINNING N88'28'13"W 401.83' (MEASURED) N88'28'13"W 403.5' (LEGAL) 17873'58"E 464.26" (RADIAL) × 11.72 × 15.52 × 18.84 N88"28"13"W 360.4 × 10.21 × 18.83 POINT OF BEGINNING POINT OF COMMENCMENT PARCEL 2 × 12.91 × 16.15 N05'00'00'E 3.21 × 12.09

1=95.81

NORTH LINE OF SECTION 11, TOWNSHIP 43S, RANGE 43E

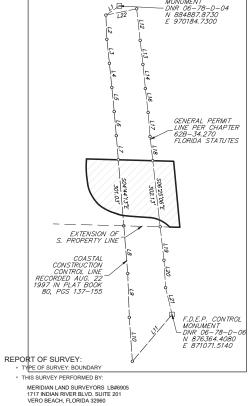

Line Table LINE LENGTH BEARING L2 1093.59' S2°18'12"E 994.62' S5°59'14"E L4 1131.94' S5°50'23"E L5 1369.08' S5°31'02"E L6 1304.21' S4°58'27"E L7 706.93' S4°44'13"E L8 217.25' S4°44'13"E L9 992,43' S2°02'26"E L10 814.50' S4°04'05"E L11 481.30' N30°45'33"E L12 | 1082.60' | S6°25'43"E L13 1010.80' S6°36'07"E L14 1121.84 S5°39'50"E L16 1344.13' S6°35'07" L17 1311.24 S4°34'08" L18 751.39' S6°25'06"E L19 153.20' S6°25'06" L20 972.17' S3°26'30"E L21 493,97' S13°36'58"E L22 32.42' N78°18'38"E

PROFESSIONAL SURVEYOR & MAPPER IN RESPONSIBLE CHARGE

CHARLES H. BLANCHARD P.S.M. #5755

AS LOCATED ON 5/15/17
×-2.29

MEAN HIGH WATER LINE — ELEV.=0.48' NAVD'88 AS LOCATED ON 5/15/17

SAND BEACH

~0.0° × -0.41

××, ×, ×, ×, 0, .

THE EXPECTED USE OF THE LAND, AS CLASSIFIED IN THE FLORIDA STANDARDS OF PRACTICE (5J-17, FLORIDA ADMINISTRATIVE CODE) IS COMMERCIAL FIIGH RISK. THE MINIMUM RELATIVE ACCURACY FOR THIS TYPE OF BOUNDARY SURVEY IS 1 FOOT IN 10,000. THE MEASUREMENT AND CALCULATION OF A CLOSED GEOMETRIC FIGURE WAS FOUND TO BE IN EXCESS OF THIS ACCURACY REQUIREMENT.

THIS SURVEY MEETS ALL APPLICABLE REQUIREMENTS OF THE FLORIDA STANDARDS OF PRACTICE AS CONTAINED IN 5J-17, FLORIDA ADMINISTRATIVE CODE.

ELEVATIONS AND DIMENSIONS SHOWN HEREON ARE MEASURED IN FEET. AND DECIMAL PARTS THEREOF

THE LAST DATE OF FIELD WORK WAS: 01/09/18

THE BEARING BASE FOR THIS SURVEY IS A GRID BEARING OF N88°28'13"W ALONG THE NORTH LINE OF SECTIONS 10 AND 11

THIS SURVEY DOES NOT CERTIFY TO THE EXISTENCE OR LOCATION OF ANY UNDERGROUND IMPROVEMENTS: UTILITIES, FOUNDATIONS, OR ENCROACHMENTS, EXCEPT AS SHOWN.

NO TITLE OPINION OR GUARANTEE IS EXPRESSED OR IMPLIED

UNLESS A COMPARISON IS SHOWN, PLAT VALUES AND MEASURED VALUES ARE THE SAME

LEGAL DESCRIPTION IS AS PROVIDED BY THE CLIENT.

UNLESS OTHERWISE INDICATED. FOUND MONUMENTATION, IS UNIDENTIFIED

THE PARCEL OF LAND SHOWN HEREON APPEARS TO BE IN FLOOD ZONES AE-7',B , C, & VE-10' PER FLOOD NSURANCE RATE MAP #120220 0001 C, DATED SEP. 30TH, 1982.

THE ELEVATIONS SHOWN HEREON ARE BASED ON THE NORTH AMERICAN VERTICAL DATUM (NAVD) OF 1988. THE BENCHMARK IS NGS CONTROL MONUMENT "872 2607 B TIDAL" ELEVATION = 3.59' NAVD'88.

THE CONVERSION FACTOR BETWEEN NAVD 1988 AND NGVD 1929 IS +1.53' THIS WAS DETERMINED USING CORPSCON FOR WINDOWS, VER.5.11.08.

WINDLOWS, VERS.11.08.

ADDITIONS OR DELETIONS TO SURVEY MAPS OR REPORTS BY OTHER THAN THE SIGNING PARTY OR PARTIES IS PROHIBITED WITHOUT WRITTEN CONSENT OF THE SIGNING PARTY OR PARTIES.

THIS SURVEY HAS BEEN ABSTRACTED FOR EASEMENTS AND ENCUMBRANCES AND SAID EASEMENTS AND ENCUMBRANCES ARE SHOWN HEREON.

GRAPHIC SCALE (IN FEET)

WESTERLY EXTENSION OF SOUTHERNMOST PROPERTY LINE



NAVD 1988 VAR #218-00084 **ARCOM B-034-2018**



MERIDIAN LAND SURVEYORS

1717 INDIAN RIVER BLVD, SUITE 201 VERO BEACH, FL. 32960 LB#6905 PHONE: 772-794-1213, FAX: 772-794-1096 EMAIL: LB6905@BELLSOUTH.NET



TYPE: BOUNDARY	REVISIONS			
PROJECT# 17-027-SP	4.	01/10/18	UPDATE TOPO WEST OF SEAWALL	СНВ
DATE: 6/12/17 F.B. PG.	3.	12/14/17	ADD ORB PAGE'S	СНВ
DRAWN BY: S.P.T.	2.	12/07/17	ADD DEDICATION	СНВ
CHECKED BY: C.H.B.	1.	08/10/17	REVISE PER TC	СНВ
SCALE: 1:30 SHEET: 1 OF 1	NO.	DATE	DESCRIPTION	BY

L=93.19 R=195.74

PLAT OF SURVEY FOR:

× 21.47

39.17' 24.15

BENCHMARK FD P/K NAIL & DISK

× 21.47

CLAREMONT PROPERTIES 901 NORTH OCEAN BOULEVARD

THIS SURVEY IS NOT VALID WITHOUT THE SIGNATURE AND THE ORIGINAL RAISED SEAL OF THE FLORIDA LICENSED SURVEYOR AND MAPPER NAMED BELOW.

CHARLES H. BLANCHARD P.S.M. #5755